MINDOM SCHEDULE					
UNIT ID	TYPE	UNIT SIZE *	HDHT FROM R	LOCATION	REMARKS
M101	MD. CSMT.	1'-6"x5'-0"	8'-1"	MINE	HALF ROUND TOP WINDOW
W102	MD. CSMT.	2'-0"x6'-0"	9'-1"	1 CAR GARAGE	HALF ROUND TOP WINDOW
M103	MD. CSMT.	3'-0"x5'-6"	8'-7"	1 CAR GARAGE	CORNER UNIT
M104	FIXED	10'-6"×5'-6"	8'-7"	1 CAR GARAGE	UNIT CONSISTS OF (4) 2'-7 1/2" X 5'-6" MULLED WINDOWS CORNER UNIT
M105	MD. CSMT.	3'-0"x5'-6"	8'-7"	1 CAR GARAGE	CORNER UNIT
W106	MD. CSMT.	2'-6"x7'-0"	10'-1"	OFFICE	UNIT CONSISTS OF 2'-6" X 5'-0" WINDOW W/ 2'-0" TALL TRANSOM
W107	FIXED	12'-0"x6'-9"	10'-1"	PREP	
W108	MD. CSMT.	5'-0"x6'-0"	8'-1"	2 CAR GARAGE	UNIT CONSISTS OF (2) 2'-6" X 6'-0" MULLED WINDOWS
M109	MD. CSMT.	5'-0"x6'-0"	8'-1"	LAUNDRY	UNIT CONSISTS OF (2) 2'-6" X 6'-0" MULLED WINDOWS
M110	AMNING	4'-0"x8'-0"	8'-1"	GUEST BATH	UNIT CONSISTS OF 4'-0" X 2'-0" AWNING WINDOW UNDER 4'-0" X 6'-0" FIXED WINDOW
M111	MD. CSMT.	4'-0"x6'-0"	8'-1"	GUEST BED	UNIT CONSISTS OF (2) 2'-0" X 6'-0" MULLED WINDOWS (EGRESSABLE)
M112	MD. CSMT.	2'-6"x6'-0"	8'-1"	GUEST BED	(EGRESSABLE)
M113	MD. CSMT.	2'-6"x6'-0"	<i>8</i> '-1"	GUEST BED	(EGRESSABLE)
M114	FIXED	9'-0"x8'-0"	<i>8</i> '-1"	BREAKFAST	UNIT CONSISTS OF (3) 3'-0" X 8'-0" MULLED WINDOWS SET SILL ON FLOOR
M115	MD. CSMT.	3'-4"x10'-0"	10'-1"	MASTER BED	CORNER UNIT.
M116	MD. CSMT.	13'-4"×10'-0"	10'-1"	MASTER BED	UNIT CONSISTS OF (4) 3'-4" X 10'-0" MULLED WINDOWS CORNER UNIT
M117	MD. CSMT.	3'-4"x10'-0"	10'-1"	MASTER BED	CORNER UNIT.
M118	MD. CSMT.	2'-0"x5'-0"	<i>8</i> '-1"	MASTER BED	
M119	MD. CSMT.	2'-0"x5'-0"	<i>8</i> '-1"	MASTER BED	
W120	AMNING	7'-6"x10'-6"	11'-9"	MASTER BATH	UNIT CONSISTS OF 7'-6" X 2'-6" AWNING WINDOW UNDER 7'-6" X 8'-0" HALF ROUND TOP FIXED WINDOW (TEMPERED
M121	MD. CSMT.	4'-0"x5'-0"	8'-1"	WARDROBE	UNIT CONSISTS OF (2) 2'-0" X 5'-0" MULLED WINDOWS
M122	MD. CSMT.	2'-0"x5'-0"	8'-1"	COMP. EQUIP.	
W123	FIXED	6'-6"x8'-0"	10'-1"	STUDY	HALF ROUND TOP WINDOW
W124	MD. CSMT.	1'-6"x5'-0"	7'-1"	STUDY	HALF ROUND TOP WINDOW
M201	MD. CSMT.	2'-0"x5'-0"	7'-1"	BATH #3	
M202	MD. CSMT.	5'-0"x5'-0"	7'-1"	BED #5	UNIT CONSISTS OF (2) 2'-6" X 5'-0" MULLED WINDOWS (EGRESSABLE)
M203	FIXED	2'-6"×2'-6"	7'-1"	BATH #5	ROUND MINDOW
M204	MD. CSMT.	5'-0"x4'-0"	7'-1"	BED #5	UNIT CONSISTS OF (2) 2'-6" X 4'-0" MULLED WINDOWS
M205	MD. CSMT.	5'-0"x5'-0"	7'-1"	BED #5	UNIT CONSISTS OF (2) 2'-6" X 5'-0" MULLED WINDOWS (EGRESSABLE)
M206	MD. CSMT.	2'-0"x3'-0"	8'-1"	STORAGE	
W207	MD. CSMT.	4'-0"×4'-6"	8'-1"	LAUNDRY	UNIT CONSISTS OF (2) 2'-0" X 4'-6" MULLED WINDOWS
M208	MD. CSMT.	5'-0"x5'-0"	7'-1"	FUTURE	UNIT CONSISTS OF (2) 2'-6" X 5'-0" MULLED WINDOWS
M209	MD. CSMT.	3'-0"x5'-0"	7'-1"	FUTURE	
M210	MD. CSMT.	2'-0"x4'-6"	8'-1"	HALL	
M211	MD. CSMT.	12'-0"x4'-6"	7'-1"	GAME ROOM	UNIT CONSISTS OF (4) 3'-0" X 4'-6" MULLED WINDOWS
M212	MD. CSMT.	2'-0"x5'-0"	7'-1"	BATH #4	
M213	MD. CSMT.	7'-6"x5'-0"	7'-1"	BED #4	UNIT CONSISTS OF (3) 2'-6" X 5'-0" MULLED WINDOWS (EGRESSABLE)
M214	FIXED	7'-6"×9'-0"	7'-10"	STAIR	TEMPERED GLASS

4. VERIFY THAT BEDROOM WINDOWS MEET APPLICABLE EGRESS CODES.
5. ALL WINDOWS ARE TO BE OPERABLE UNLESS NOTED FIXED ("FXD").
6. HEAD HEIGHTS SHOWN ARE TO THE TRANSOM ROUGH OPENING UNLESS NOTED OTHERWISE.

7. WIXX MEANS WINDOW IS LOCATED ON 1ST FLOOR. W2XX MEANS WINDOW IS LOCATED ON 2ND FLOOR.

D102	3'-0"	7'-0"	EXTERIOR	DINING	3'-0' X 7'-0" FRENCH DOOR W/ 3'-0" ELIPTICAL TRANSOM AND 2'-10" SIDE LITES BOTH SIDES.
D103	8'-0"	8'-0"	OVERHEAD	1 CAR GARAGE	DOOR PANEL PER ELEVATIONS
D104	2'-6"	8'-0"	EXTERIOR	1 CAR GARAGE	FRENCH DOOR
D105	3'-0"	8'-0"	EXTERIOR	BUTLERY	FRENCH DOOR
D106	18'-0"	8'-0"	OVERHEAD	2 CAR GARAGE	DOOR PANEL PER ELEVATIONS
D107	3'-0"	8'-0"	EXTERIOR	LOGGIA	FRENCH DOOR
D108	3'-0"	8'-0"	EXTERIOR	LOGGIA	FRENCH DOOR
D109	3'-0"	8'-0"	EXTERIOR	HALL	FRENCH DOOR
D110	12'-0"	8'-0"	EXTERIOR	BREAKFAST	(4) 3'-0" X 8'-0" SLIDING FRENCH DOORS
D111	21'-0"	8'-0"	EXTERIOR	LOGGIA	(7) 3'-0" X 8'-0" FOLDING FRENCH DOORS
D112	6'-8"	10'-0"	EXTERIOR	FAMILY ROOM	(3) PAIR OF 3'-4" X 10'-0" FRENCH DOORS FIXED, OPP, FIXED (REF PLAN)
D113	5'-0"	8'-0"	EXTERIOR	MASTER BED	PAIR OF 2'-6" x 8'-0" FRENCH DOORS
D114	5'-0"	8'-0"	EXTERIOR	MASTER BED	PAIR OF 2'-6" x 8'-0" FRENCH DOORS
D115	3'-0"	8'-0"	INTERIOR	MASTER BED	TAIR OF 2 & A & & TRENOT BOOKS
D116	3'-6"	8'-0"	INTERIOR	MASTER BATH	PAIR OF 1'-6" x 8'-0" DOORS
D117	3'-0"	6'-8"	GLASS DOOR	MASTER BATH	TEMPERED GLASS SHOWER DOOR VERIFY SIZE WITH BUILDER
D118	2'-6"	8'-0"	INTERIOR	MASTER BATH	TEMI EINED CEASS SHOMEN DOON VENIT SIZE MITH BUILDEN
D119	3'-0"	8'-O"	INTERIOR	WARDROBE	
D120	2'-6"	8'-0"	INTERIOR	COMP. EQUIP.	PAIR OF 2'-0" x 8'-0" DOORS
D121	4'-0"	8'-0"	INTERIOR	STUDY	PAIR OF 2-0" X 8-0" DOORS
D122	2'-6"	8'-0"	INTERIOR	POWDER	
D123	2'-0"	8'-0"	INTERIOR	COATS	
D124	2'-6"	8'-0"	INTERIOR	MINE	
D125	3'-0"	8'-0"	INTERIOR	BUTLERY	
D126	2'-6"	8'-0"	INTERIOR	OFFICE	POCKET DOOR
D127	3'-0"	8'-0"	INTERIOR	PANTRY	POCKET DOOR
D128	3'-0"	8'-0"	INTERIOR	2 CAR GARAGE	MEATHER TIGHT
D129	4'-0"	8'-0"	INTERIOR	STORAGE	PAIR OF 2'-0" x 8'-0" DOORS
D130	3'-0"	ව'-O"	INTERIOR	LAUNDRY	POCKET DOOR
D131	2'-6"	ව'-O"	INTERIOR	COATS	
D132	2'-4"	8'-0"	INTERIOR	POOL BATH	
D133	2'-8"	8'-0"	INTERIOR	GUEST BED	
D134	2'-6"	8'-0"	INTERIOR	CLOSET	
D135	2'-6"	8'-0"	INTERIOR	GUEST BATH	
D136	2'-6"	6'-8"	GLASS DOOR	GUEST BATH	TEMPERED GLASS SHOWER DOOR VERIFY SIZE WITH BUILDER
D201	2'-6"	8'-0"	INTERIOR	ATTIC	WEATHER TIGHT
D202	2'-6"	8'-0"	INTERIOR	CLOSET #4	
D203	2'-6"	8'-0"	INTERIOR	BATH #4	
D204	2'-8"	8'-0"	INTERIOR	BED #4	
D205	2'-6"	6'-8"	GLASS DOOR	BATH #3	TEMPERED GLASS SHOWER DOOR VERIFY SIZE WITH BUILDER
D206	2'-6"	ව'-O"	INTERIOR	CLOSET #3	
D207	2'-6"	9'-0"	INTERIOR	BATH #3	
D208	3'-0"	ව'-O"	INTERIOR	BED #3	
D209	2'-0"	6'-8"	GLASS DOOR	BATH #5	TEMPERED GLASS SHOWER DOOR VERIFY SIZE WITH BUILDER
D210	2'-6"	8'-0"	INTERIOR	CLOSET #5	
D211	2'-6"	8'-0"	INTERIOR	BATH #5	
D212	2'-8"	8'-0"	INTERIOR	BED #5	
D213	2'-6"	8'-0"	INTERIOR	ATTIC	WEATHER TIGHT
D214	4'-0"	8'-0"	INTERIOR	STORAGE	PAIR OF 2'-0" x 8'-0" DOORS
D215	2'-6"	8'-0"	INTERIOR	STORAGE	
D216	4'-0"	6'-8"	INTERIOR	STORAGE	PAIR OF 2'-0" x 6'-8" DOORS
D217	2'-8"	8'-0"	INTERIOR	LAUNDRY	
D218	2'-8"	8'-0"	INTERIOR	FUTURE	
D219	3'-0"	හ'-O"	INTERIOR	ATTIC	WEATHER TIGHT
1 - 1 - 1	-				
				DC	OOR SCHEDULE NOTES

DOOR SCHEDULE

D101 3'-0" T'-0" EXTERIOR ENTRY FOYER 3'-0' X 7'-0" FRENCH DOOR W/ 3'-0" ELIPTICAL TRANSOM AND 2'-6" SIDE LITES BOTH SIDES.

REMARKS

3. ALL GLASS LITES ARE TO BE HIGH PERFORMANCE INSULATED GLASS. 4. D1XX MEANS DOOR IS LOCATED ON 1ST FLOOR. D2XX MEANS DOOR IS LOCATED ON 2ND FLOOR.

LOCATION

OPENING SIZE

1. THE DOOR SELECTIONS SHOWN ARE GENERIC. THE CONTRACTOR AND SUPPLIER SHALL VERIFY THAT ALL DOOR SIZES AND TYPES MEET THE DESIGN INTENT AND PROVIDE A SCHELULE TO THE ARCHITECT FOR REVIEW AND APPROVAL.

2. PROVIDE TEMPERED GLASS WHERE REQUIRED BY APPLICABLE BUILDING CODES.

MARK

	SHEET INDEX	
ID	NAME	
A1.1	SITE PLAN, GEN NOTES	
A1.2	F.O. SCHEDULE	
A2.1	FIRST FLOOR PLAN	
A2.2	SECOND FLOOR PLAN	
A3.1	ROOF PLAN	
A4.0	SKETCHES	
A4.1	ELEVATIONS	
A4.2	ELEVATIONS	
A4.3	BUILDING SECTIONS	
A5.1	MALL SECTION AND DETAILS	
A5.2	DETAILS	
E1.1	FIRST FLOOR ELECTRICAL PLAN	
E1.2	SECOND FLOOR ELECTRICAL PLAN	

SQUARE FOOT	AE	E TA	B.	
LOCATION		A.C. SQUARE OOTAGE	MISC. SQUARE FOOTAGE	
FIRST FLOOR	FIRST FLOOR 4,995 sq.ft			
SECOND FLOOR	2,4	172 sq ft		
TOTAL AIR CONDITIONED SPACE	7,46	57 sq ft		
GARAGES				
COVERED PORCHES				
FUTURE SPACE			540 sq ft	
TOTAL UNDER ROOF		9,73!	5 sq ft	
LOT SIZE			17,065 sq ft	
TOTAL LOT COVERAGE	23 sq ft			
LOT COVERAGE %	62%			



1. THE WINDOW SELECTIONS SHOWN ARE GENERIC. THE CONTRACTOR AND SUPPLIER

SHALL VERIFY THAT ALL DOOR SIZES AND TYPES MEET THE DESIGN INTENT AND PROVIDE A SCHELULE TO THE ARCHITECT FOR REVIEW AND APPROVAL.

2. PROVIDE TEMPERED GLASS WHERE REQUIRED BY APPLICABLE BUILDING CODES.

3. GLASS LITES ARE TO BE HIGH PERFORMANCE INSULATED GLASS.

GENERAL NOTES

 ALL CONSTRUCTION TO COMPLY WITH APPLICABLE BUILDING CODES, DEED RESTRICTIONS, AND RELATED REGULATIONS. 2. BRING ALL ERRORS, OMISSIONS, AND DISCREPANCIES TO THE ATTENTION OF THE ARCHITECT. 3. NOTIFY THE ARCHITECT IN THE EVENT OF INCONSISTENCIES BETWEEN ACTUAL FIELD CONDITIONS AND THE CONSTRUCTION DOCUMENTS.

4. STRUCTURAL, MECHANICAL, LIGHTING, LANDSCAPE, AND ANY OTHER ADDITIONAL CONSULTANTS ARE TO BE CONTRACTED BY THE OWNER. 5. VERIFY LOCATION OF ALL UTILITIES SERVING THE SITE. 6. FOR DIMENSIONING PURPOSES:

- a. DO NOT SCALE DRAWINGS. b. ALL INTERIOR WALLS ARE 2X4 STUDS DIMENSIONED TO ONE FACE
- b. ALL INTERIOR WALLS ARE 2X4 STUDS DIMENSIONED TO ONE FACE OF STUD AT 3 1/2" TYPICAL.
 c. STRUCTURAL WALLS WITH 2X4 STUDS AT 16" O.C. ARE ACCEPTABLE ONLY TO A HEIGHT OF 12 FEET. 2X4 STUD WALLS EXCEEDING 12 FEET IN HEIGHT WILL REQUIRE STRUCTURAL ANALYSIS TO VERIFY STUD SPACING AND/OR ADDITIONAL BRACING.
 d. ALL INTERIOR WALLS OTHER THAN 2X4 STUDS WILL BE DIMENSIONED "OUT TO OUT" OR FACE OF STUD TO OPPOSITE FACE OF STUD, i.e. 2X6'S 5 1/2" 2X8'S 7 1/4" FTC. 2X6'S - 5 1/2", 2X8'S - 7 1/4", ETC. e.EXTERIOR MASONRY WALLS ARE AS FOLLOWS; 2X4's: 9" FACE OF MASONRY TO FACE OF STUD. 2X6's: 11" FACE OF MASONRY TO FACE OF STUD.

7. PLATE " WALL " HEIGHTS ARE REFERENCED ON THE ROOF PLAN AND THE ELEVATIONS. THEY ARE TO BE COORDINATED WITH THE EAVE AND RAKE DETAILS.

8. CONSTRUCTION ASSEMBLY SYSTEMS ARE SPECIFIED ON THE WALL SECTIONS AND REFERENCED TO IN SUBSEQUENT DETAILS. 9. REFERENCE FLOOR PLANS FOR WINDOW SIZE AND HEAD HEIGHT UNLESS A WINDOW SCHEDULE IS PROVIDED. 10. UNLESS SHOWN ON PLANS, HVAC AND WATER HEATER LOCATION AND SERVICE REQUIREMENTS TO BE DETERMINED BY OTHERS. 11. LOCATION AND SIZE REQUIREMENTS FOR HVAC DUCT CHASES TO BE VERIFIED BY HVAC SYSTEM DESIGNER. COORDINATE THE LOCATION OF NEW OR LARGER CHASES WITH THE ARCHITECT.

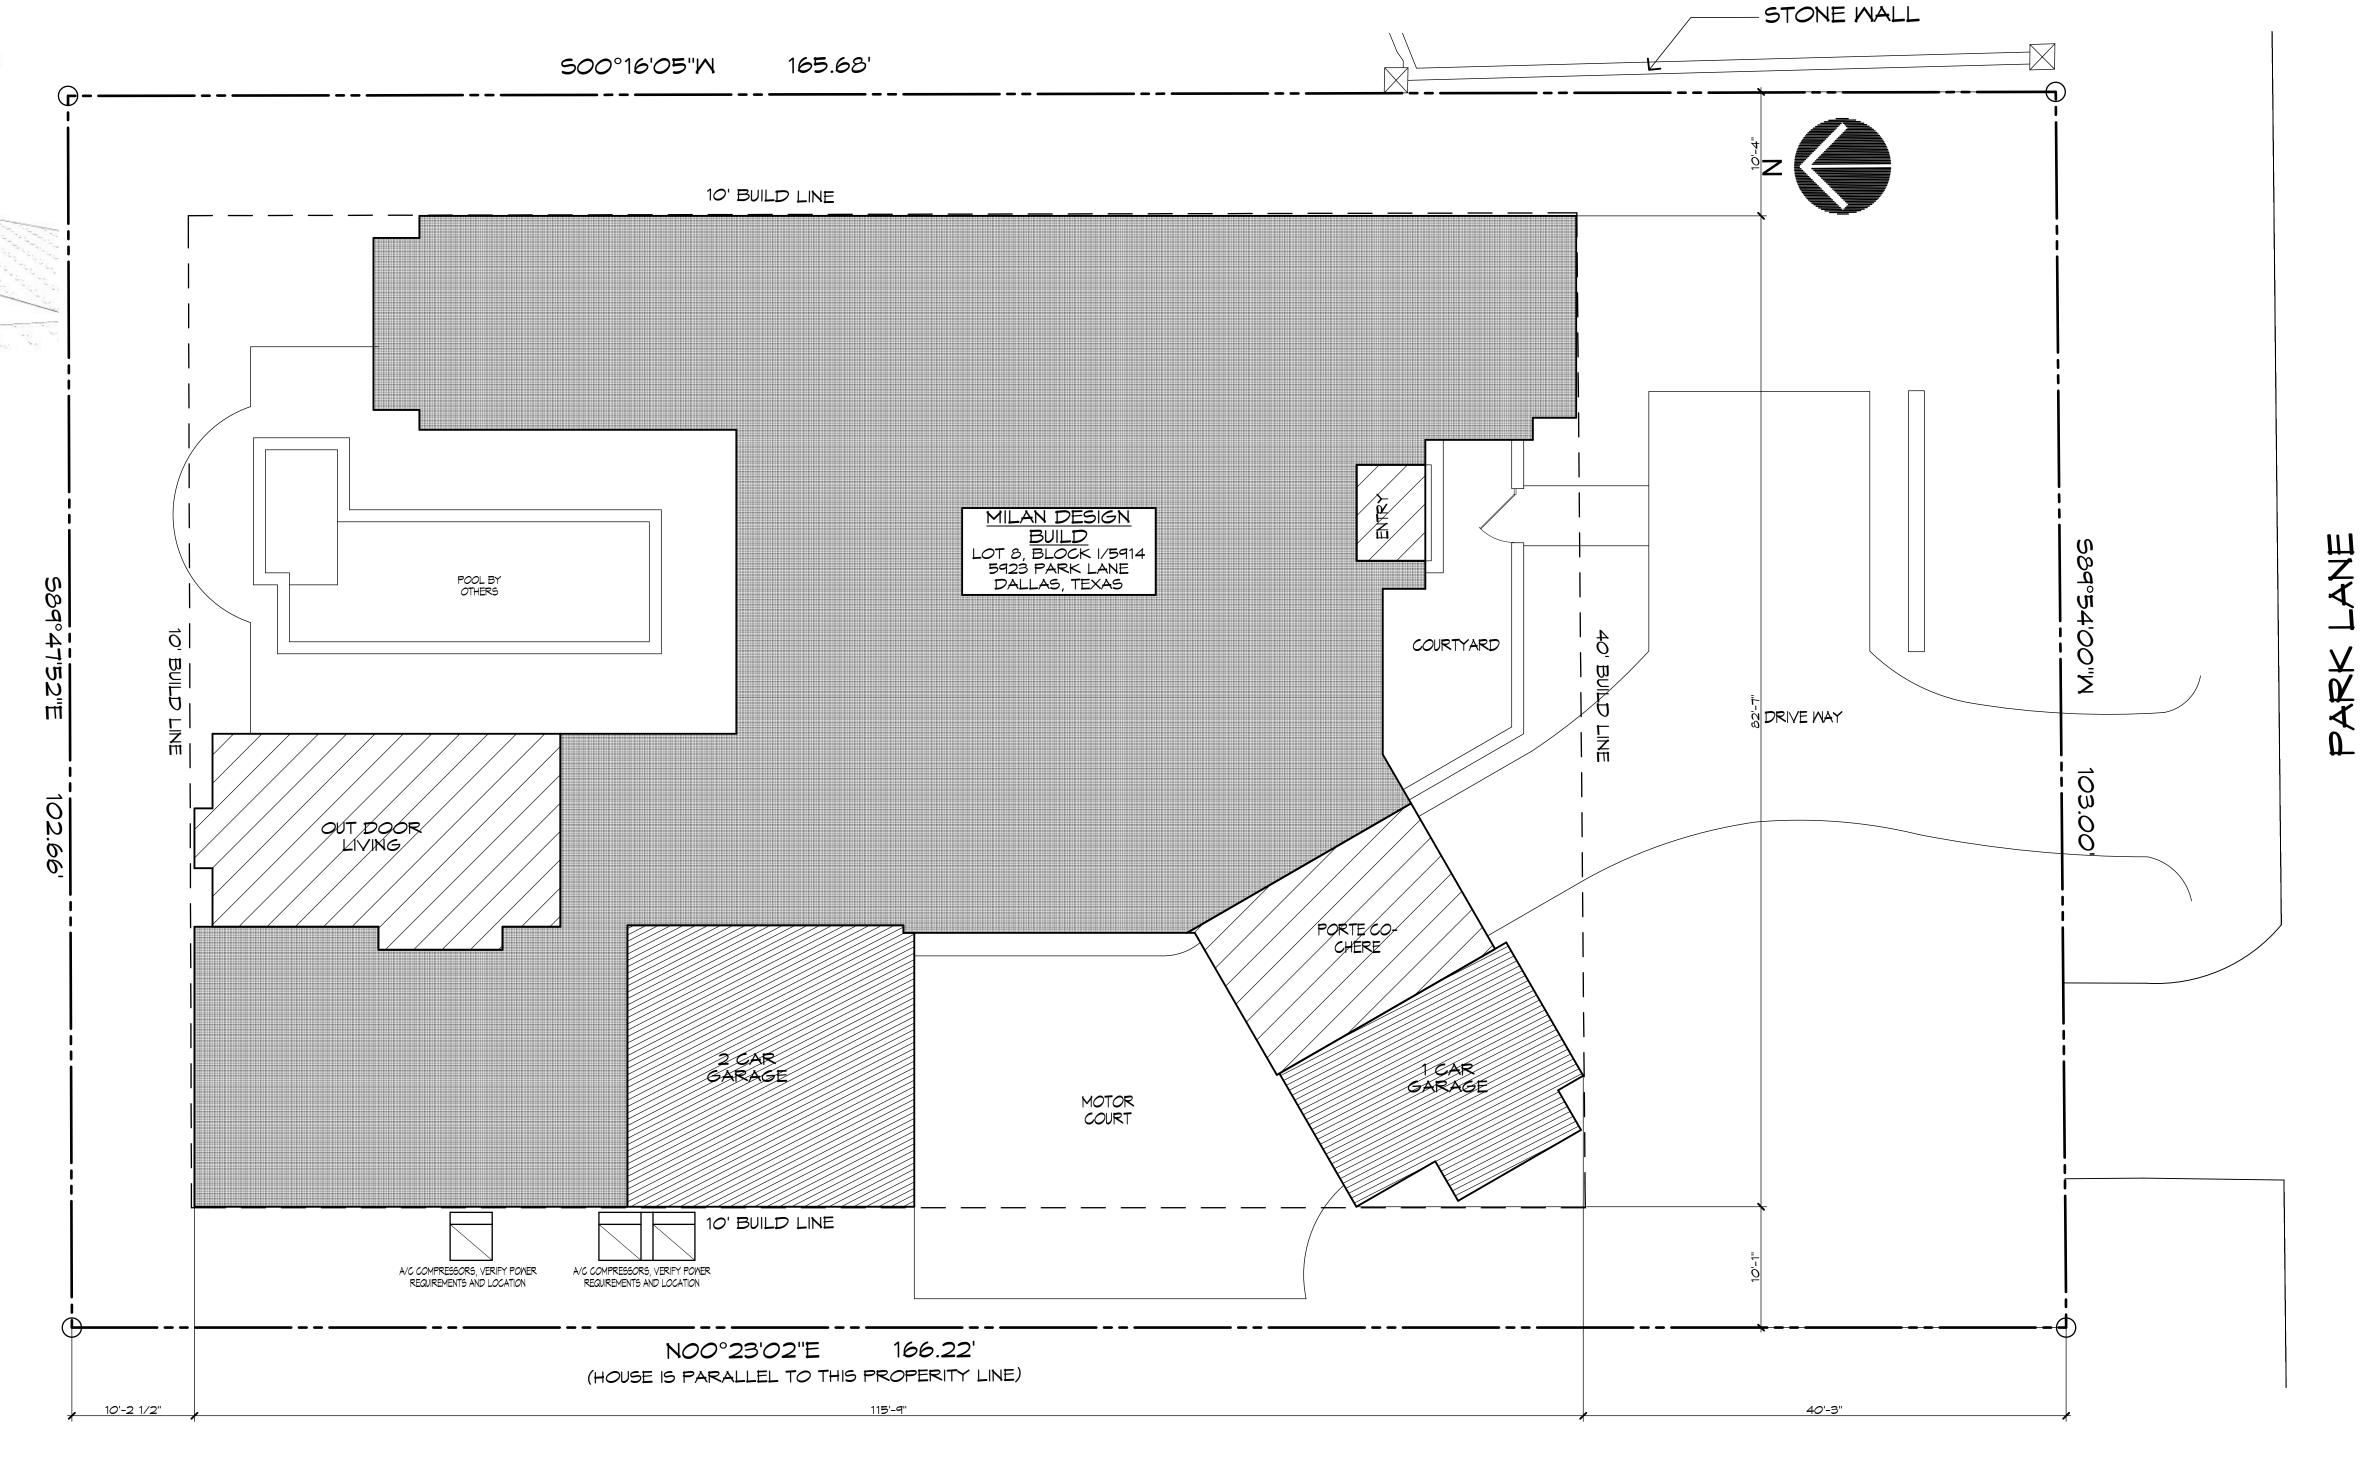
12. LOCATE KITCHEN COOKTOP VENTHOOD EXHAUST FAN MOTOR IN THE ATTIC. 13. SLEEVE ALL COPPER PIPE PENETRATIONS THROUGH CONCRETE SLABS OR WALLS. 14. LOCATE SHOWER HEADS AT 7'-0 A.F.F. UNLESS NOTED OTHERWISE

15. FOAM SEAL ALL INTERIOR AND EXTERIOR WALL CAVITY OPENINGS, i.e. HOSE BIBS, ELECTRICAL BOXES, ETC.. 16. SEAL ALL SILL PLATES.

17. PROVIDE SOLID LUMBER BLOCKING IN WALL FOR MISCELLANEOUS FIXTURES AND HARDWARE, i.e. TOWEL BARS, CLOSET SHELVING, CABINETS, CEILING FANS, ETC., WHERE SUCH FIXTURES ARE INDICATED 18. GENERAL CONTRACTOR TO VERIFY THAT THE WINDOWS USED WHERE EGRESS IS REQUIRED MEET THE APPLICABLE CODE. 19. ALL PERIMETER DRAIN SYSTEMS ARE TO BE TIED TO A SUMP PUMP UNLESS THE NATURAL GRADE PERMITS A SLOPED DRAIN TO DAYLIGHT.

VENT CLOTHES DRYER TO OUTSIDE IN ACCORDANCE WITH APPLICABLE CODES.

21. ADJUST THE HEIGHT OF FLOOR STRUCTURE TO ALIGN ALL FINISH SURFACES UNLESS SPECIFICALLY INDICATED OTHERWISE. 22. VERIFY SPRINKLER/FIRE SUPRESSION SYSTEM INSTALLATION AND REQUIREMENTS PER THE CITY OF RESIDENCE.



SITE PLAN 1/8

Z 65 0

SCALE: 1/8" = 1'-0"

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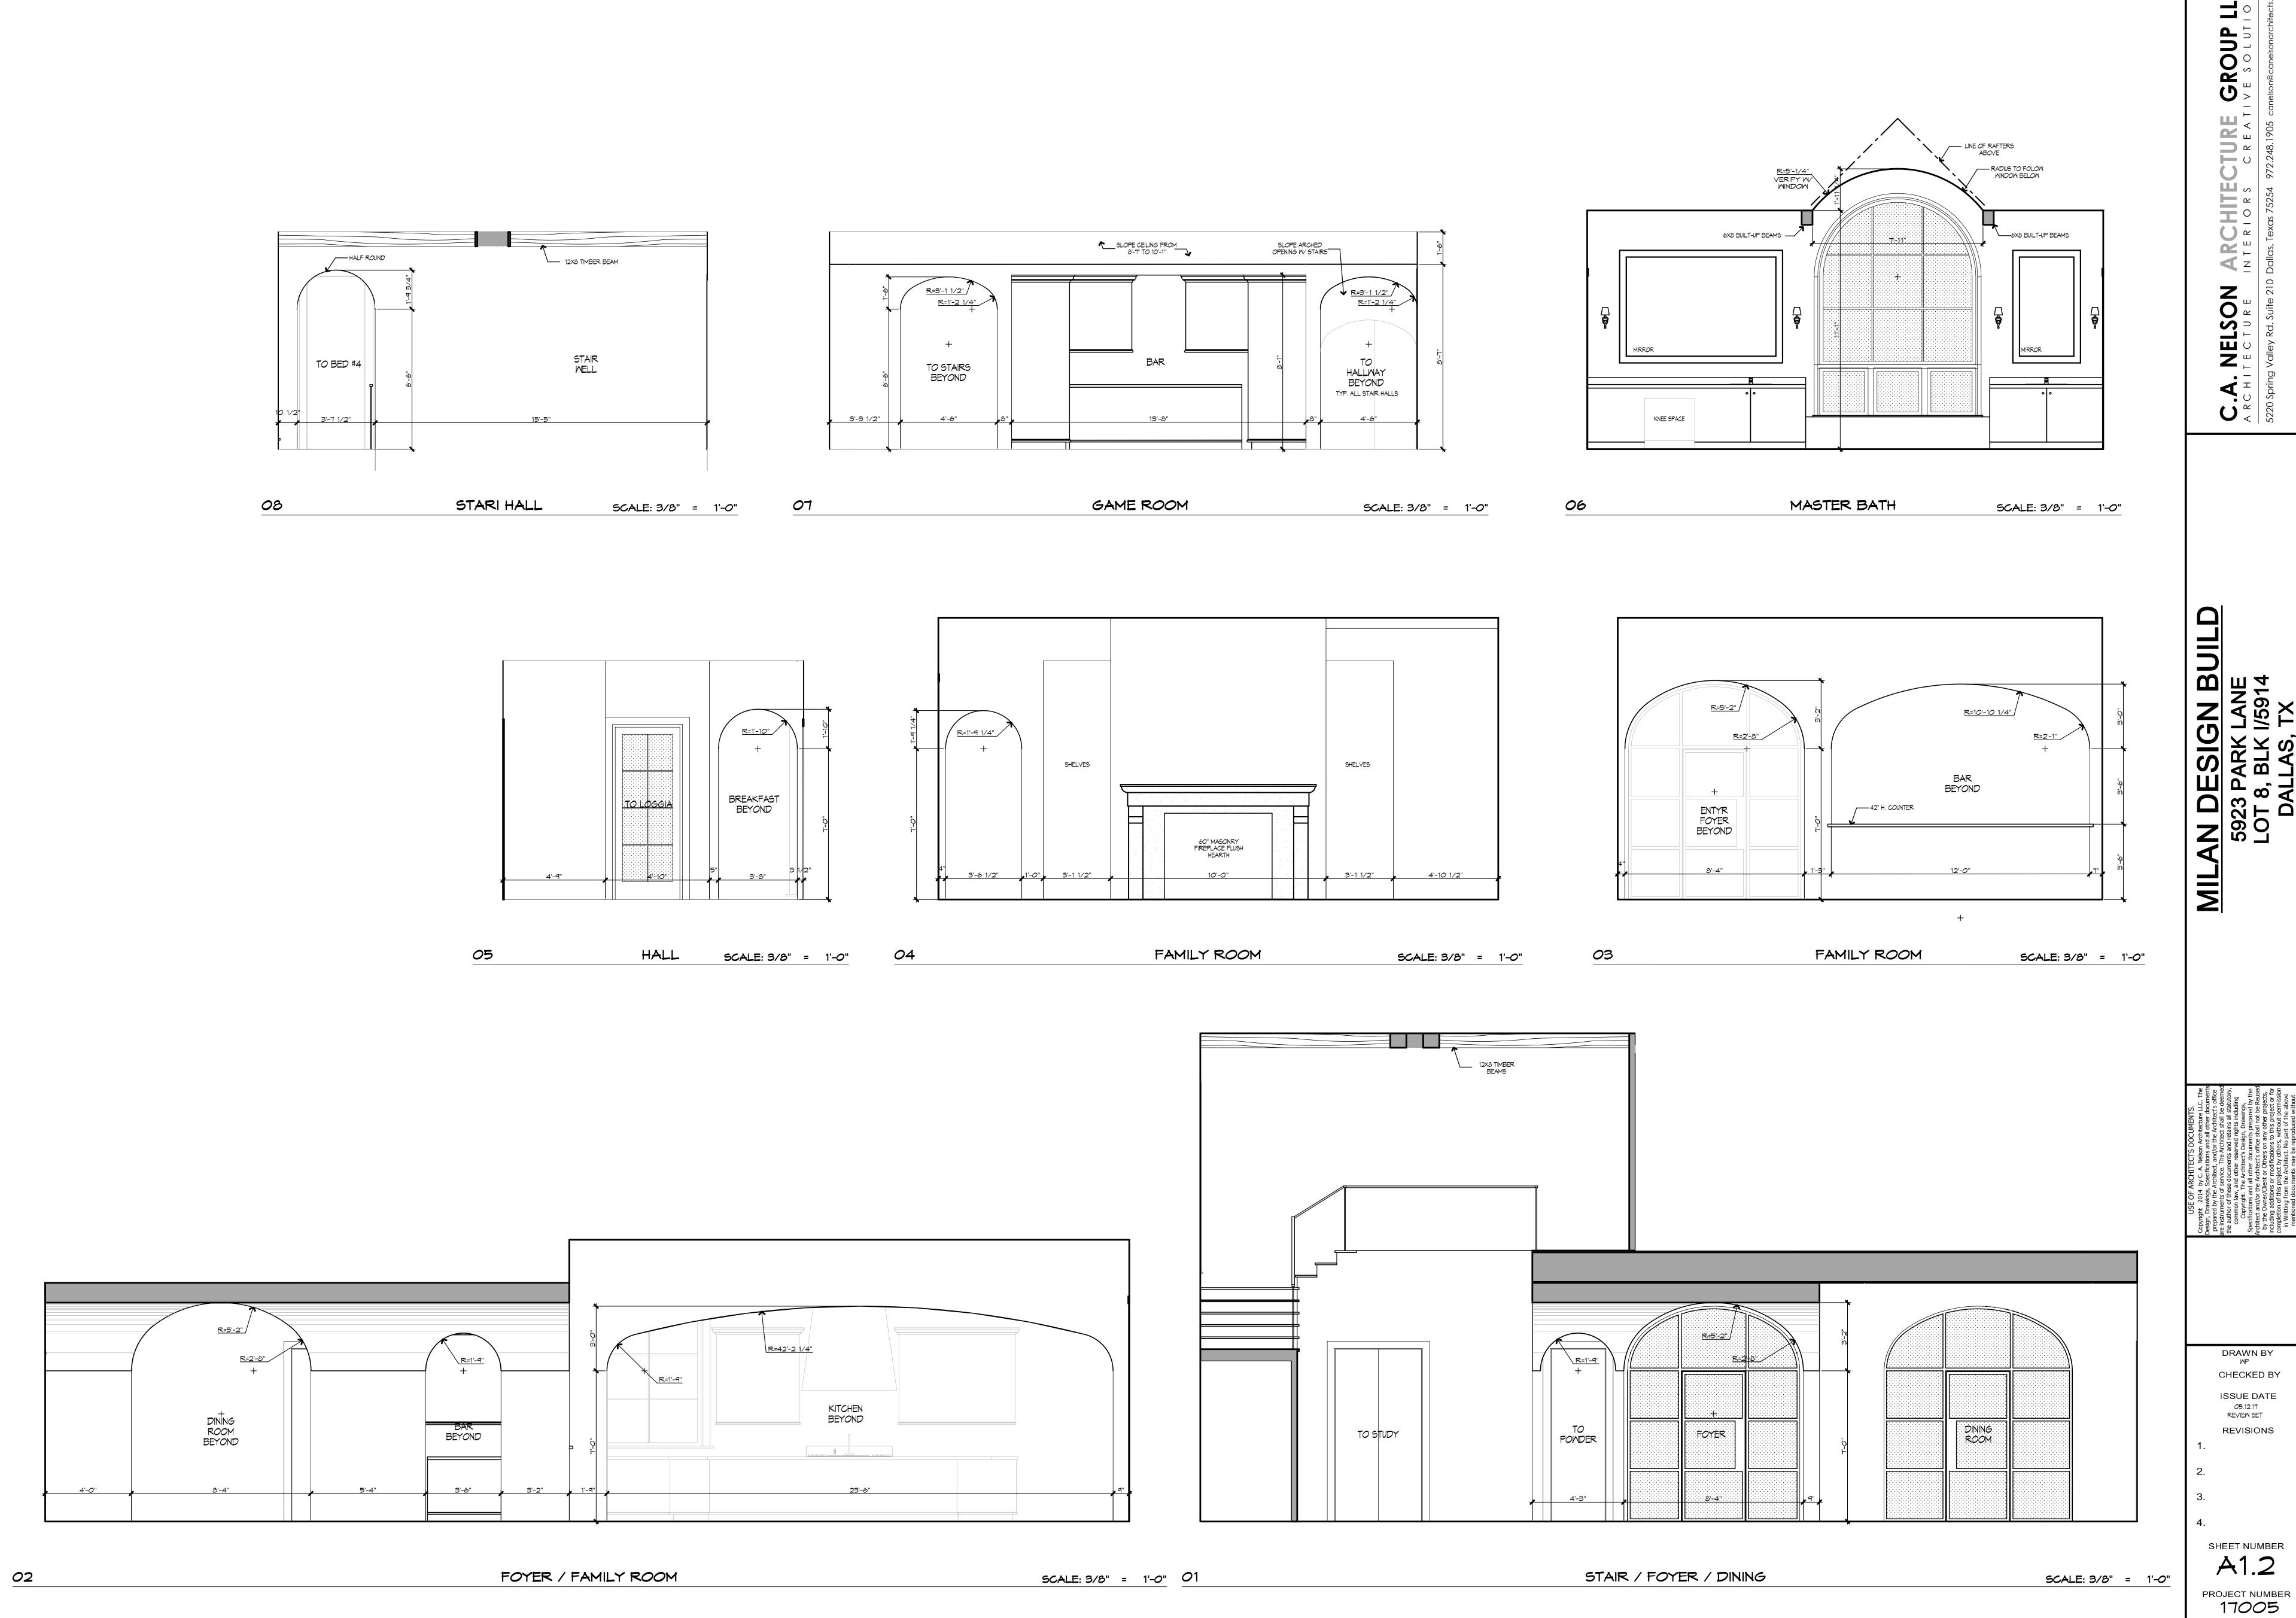
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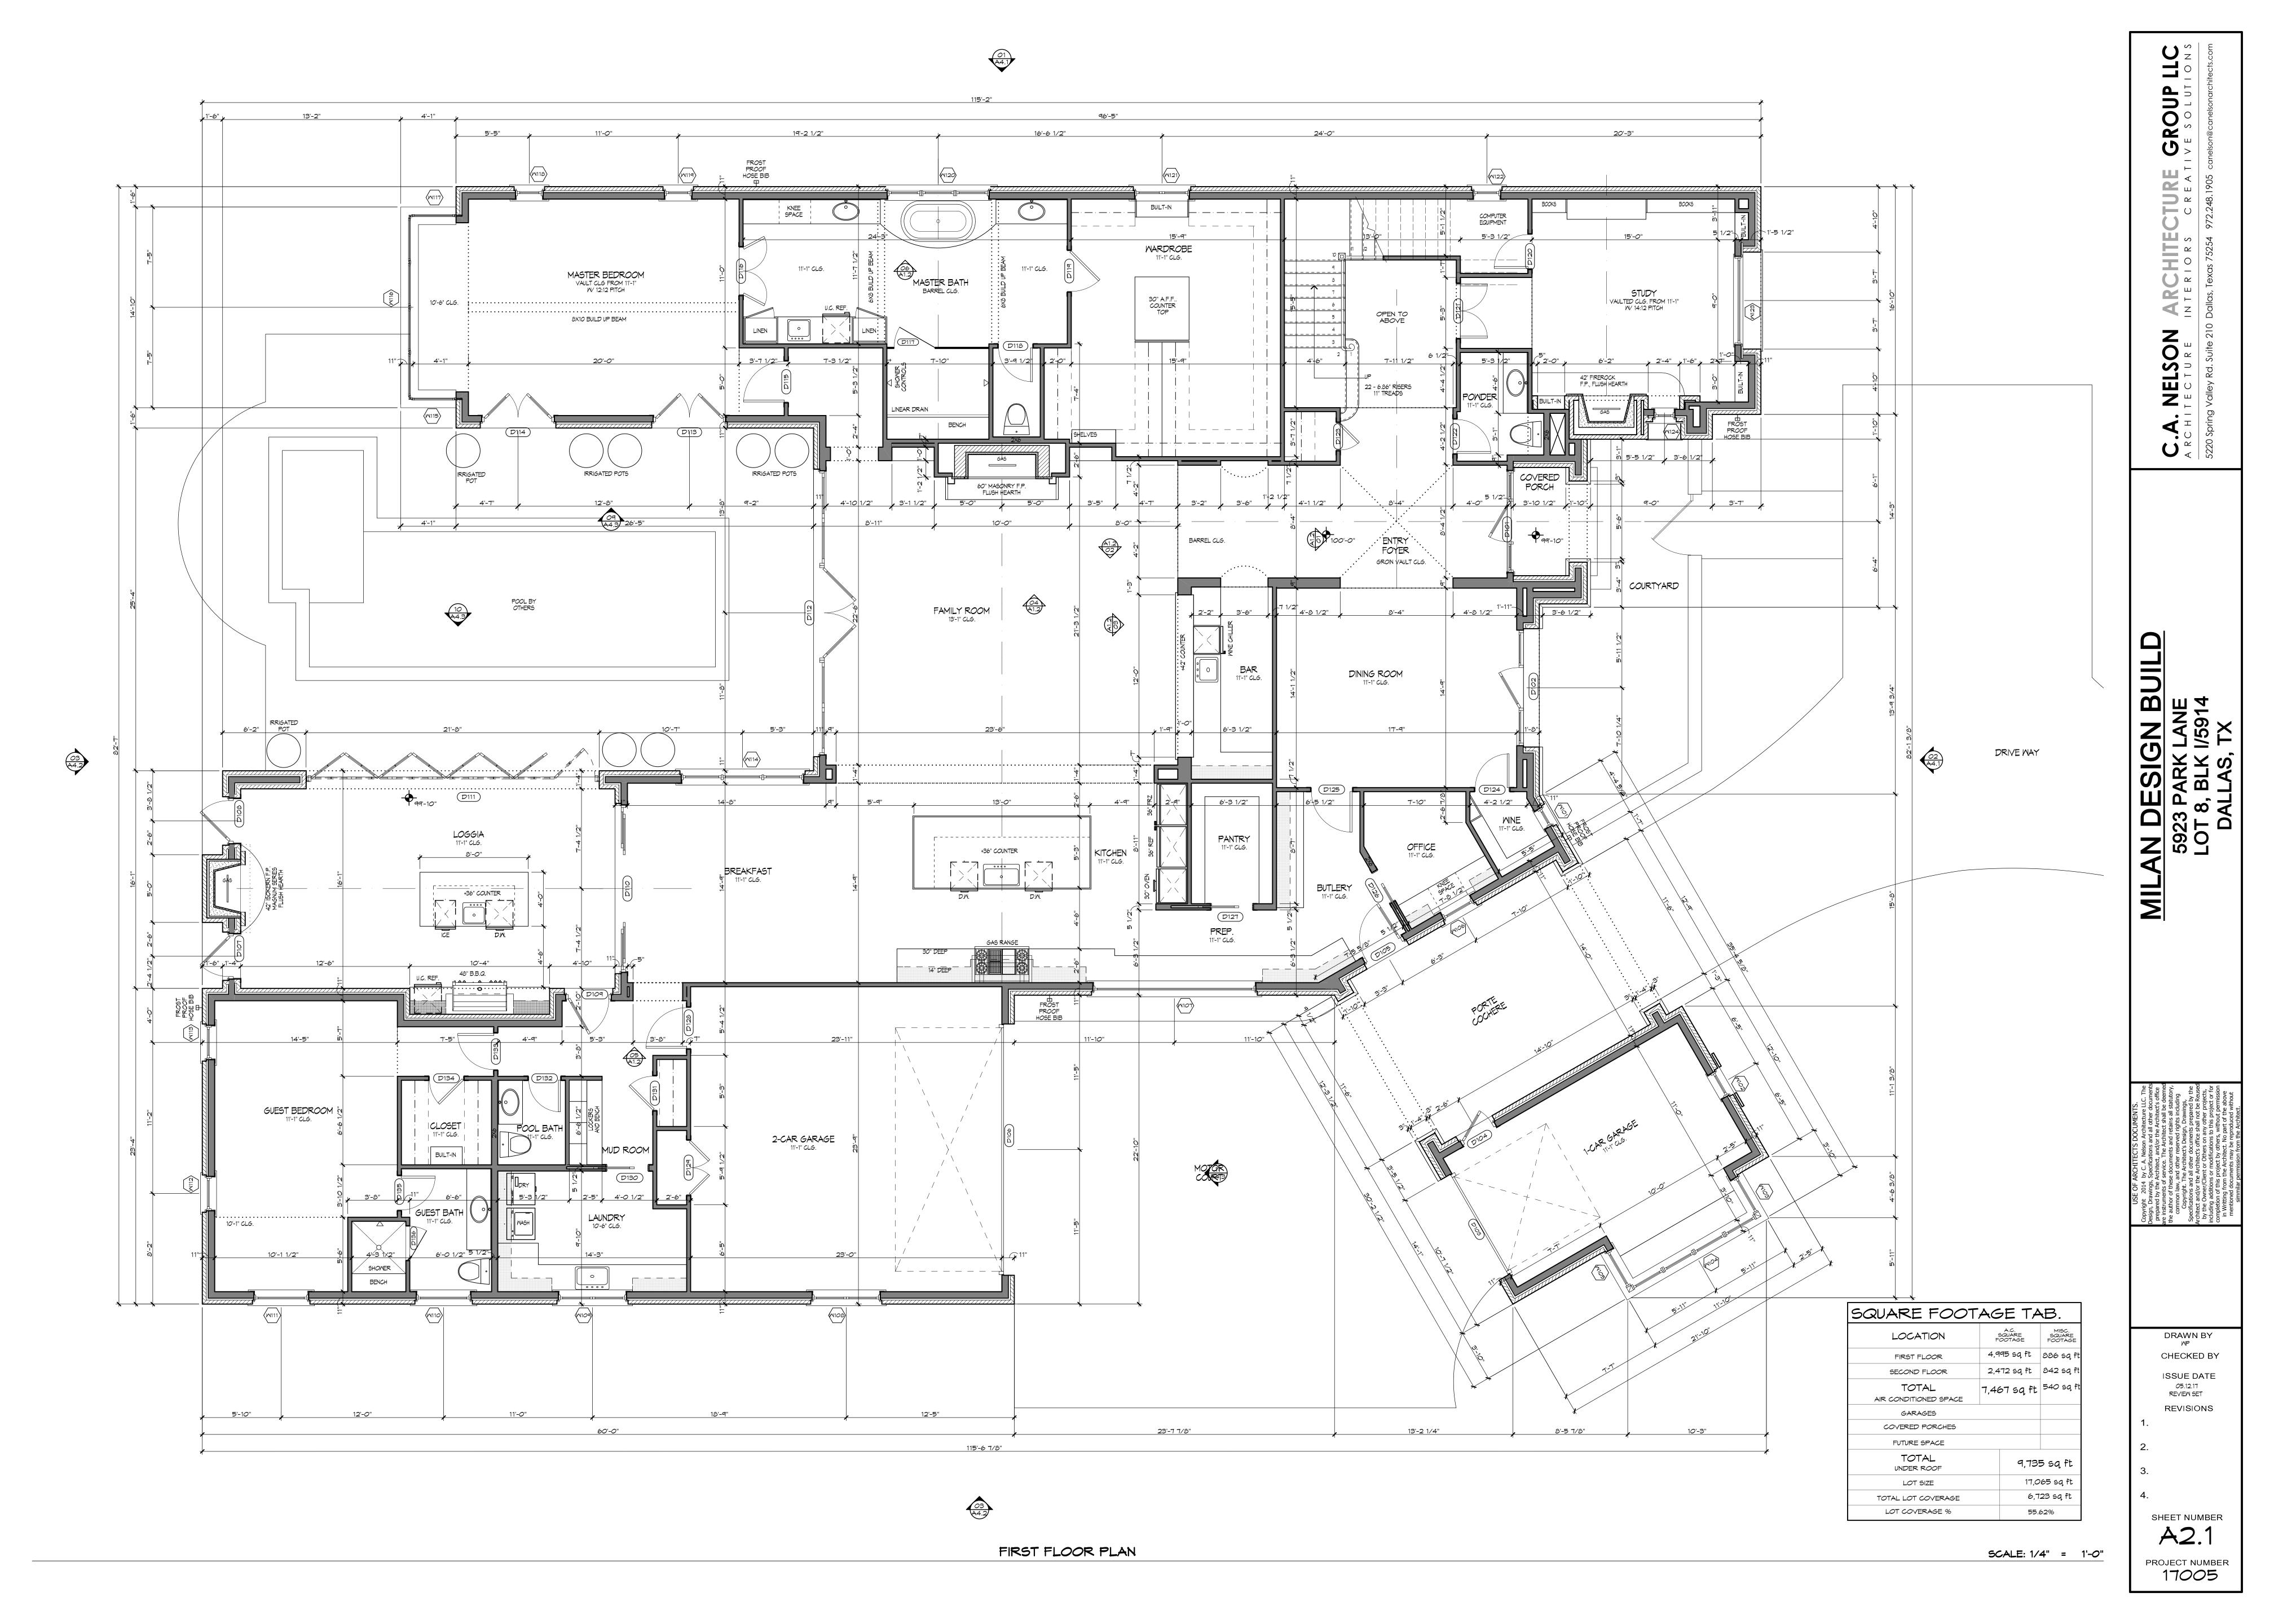
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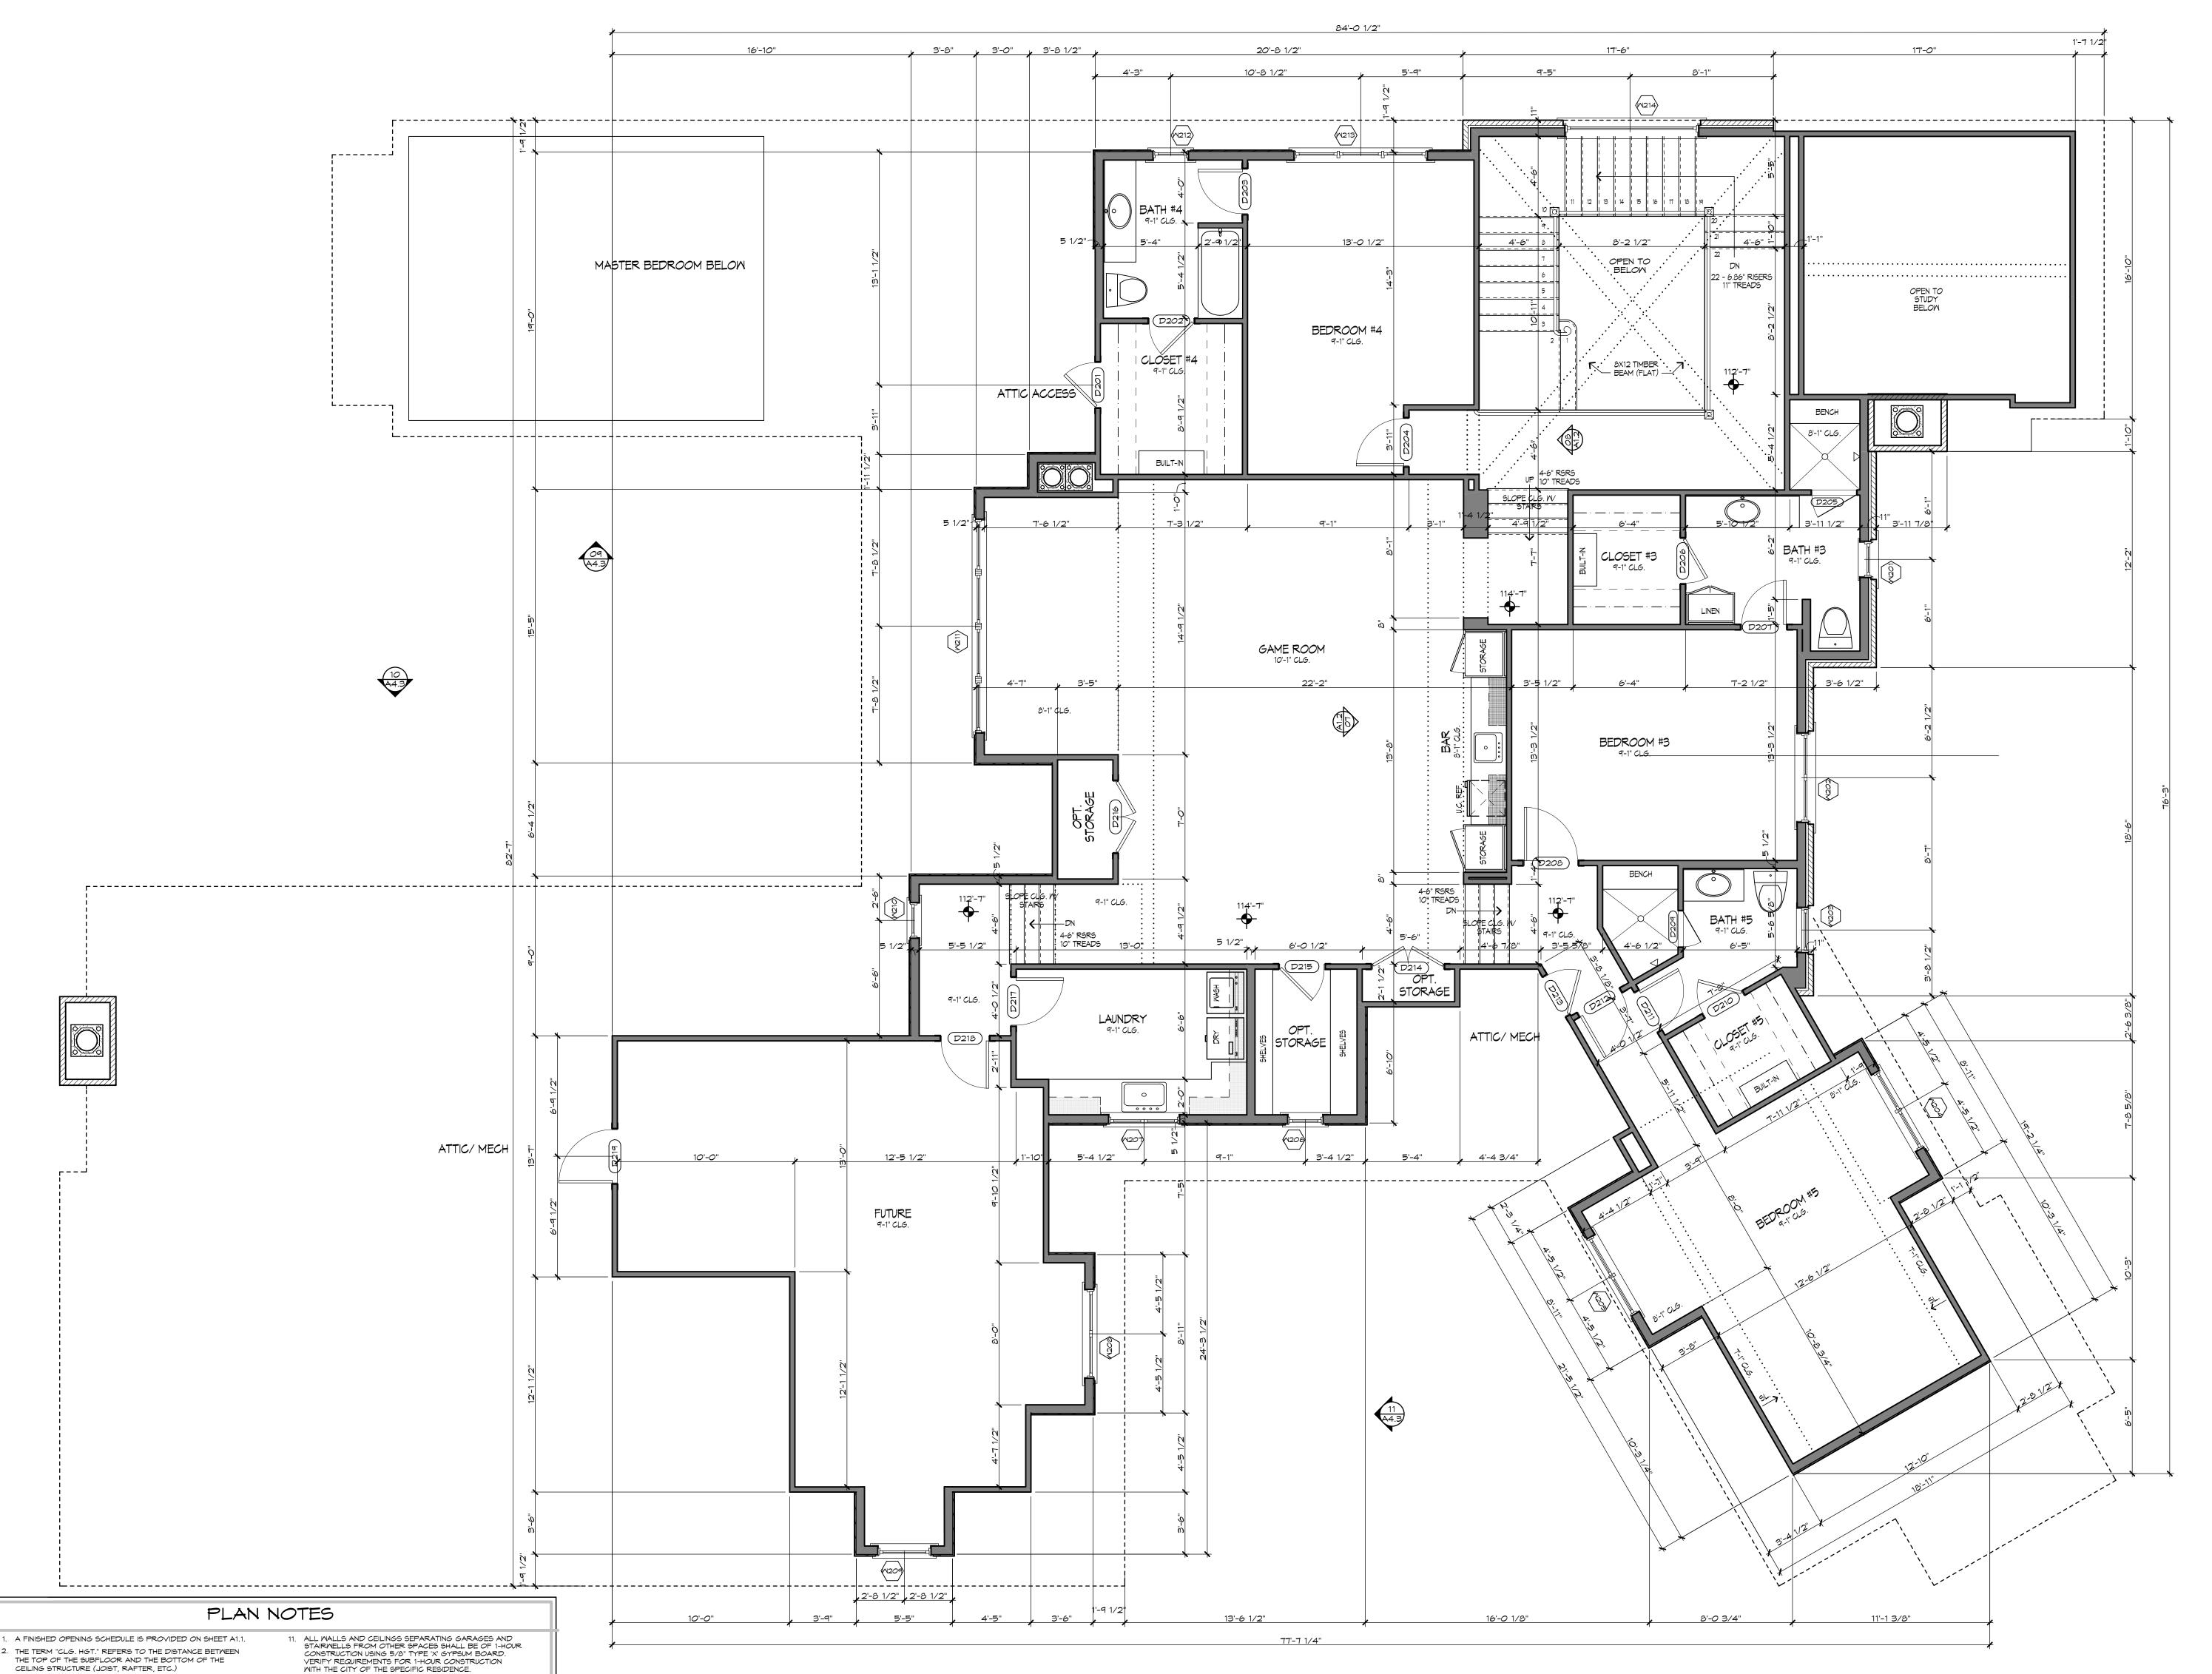
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SQUARE FOOTAGE TAB.						
LOCATION	A.C. SQUARE FOOTAGE		MISC. SQUARE FOOTAGE			
FIRST FLOOR	4,9	195 sq ft				
SECOND FLOOR	172 sq ft					
TOTAL AIR CONDITIONED SPACE	57 sq ft					
GARAGES			886 sq			
COVERED PORCHES			842 sq			
FUTURE SPACE			540 sq			
TOTAL UNDER ROOF		9,73	5 sq ft			
LOT SIZE		17,0	65 sq ft			
TOTAL LOT COVERAGE		6,7	23 sq ft			
LOT COVERAGE %		55.6	52%			

SCALE: 1/4" = 1'-0"

O3 A4.2

17. PROVIDE RAILINGS AT STEPS WITH 4 OR MORE RISERS. 18. INDIVIDUAL ROOM SQUARE FOOTAGE PROVIDED ARE APPROXIMATE FROM FACE OF STUD TO FACE OF STUD FOR GRAPHIC PURPOSE ONLY. THESE NUMBERS DO NOT ADD TO THE SUM OF THE TOTAL SQUARE FOOTAGE.

WITH THE CITY OF THE SPECIFIC RESIDENCE.

ALL DOORS ENTERING INTO POOL AREA IN REAR YARD TO BE EQUIPPED WITH ALARM PER 2006 IRC.

ALL PREFABRICATED FIRE PLACES ARE TO BE INSTALLED PER MANUFACTURERSS SPECIFICATIONS.

14. ALL INTERIOR FIREPLACES REQUIRE COMBUSTION AIR FROM EXTERIOR PER 2006 IRC. VENT AIR THROUGH CRAINL SPACE AT ALL LOCATIONS. COMBUSTION AIR VENTS TO MATCH TYPICAL CRAINL SPACE VENTS.

15. STAIR HANDRAILS TO BE SET 34" MINIMUM TO 38" MAXIMUM ABOVE TREAD NOSING. BALUSTERS TO BE SPACED SO AS NOT TO ALLOW PASSAGE OF A 4" DIAMETER SPHERE.

16. GUARD RAILS AT PORCHES, BALCONIES OR AT SURFACES RAISED 30" OR MORE ABOVE FLOOR OR GRADE BELOW TO BE SET AT A MINIMUM HEIGHT OF 36". BALUSTERS TO BE SPACED SO AS NOT TO ALLOW PASSAGE OF A 4" DIAMETER SPHERE.

3. SLOPE CONCRETE OF ALL EXTERIOR PORCHES AND GARAGES

IT IS THE INTENT FOR ALL TRANSOM LITES TO BE IDENTICAL IN SIZE TO THE LITES OF THE MAIN WINDOW OR DOOR IN BOTH WIDTH AND HEIGHT.

5. THE WINDOW AND DOOR SELECTIONS ARE GENERIC. THE

PROVIDE TEMPERED GLASS WHERE REQUIRED BY APPLICABLE BUILDING CODES.

7. ALL GLASS LITES ARE TO BE HIGH PERFORMANCE

8. VERIFY THAT REQUIRED WINDOWS AND DOORS MEET ALL

9. HEADER HEIGHTS SHOWN ARE TO THE TRANSOM ROUGH OPENING UNLESS NOTED OTHERWISE.

10. DOOR SIZES NOTED AS FOLLOWS: 2680 REFERS TO A 2'-6" WIDE, 8'-0" TALL DOOR

AND APPROVAL.

INSULATED GLASS.

APPLICABLE EGRESS CODES.

AWAY FROM THE MAIN HOUSE AT A MINIMUM OF 1/8" PER FOOT.

CONTRACTOR AND SUPPLIER SHALL VERIFY THAT ALL MINDOM AND DOOR SIZES AND TYPES MEET THE DESIGN INTENT AND PROVIDE A SCHEDULE TO THE ARCHITECT FOR REVIEW

SECOND FLOOR PLAN

CHECKED BY ISSUE DATE 05.12.17 REVIEW SET REVISIONS SHEET NUMBER PROJECT NUMBER 17005

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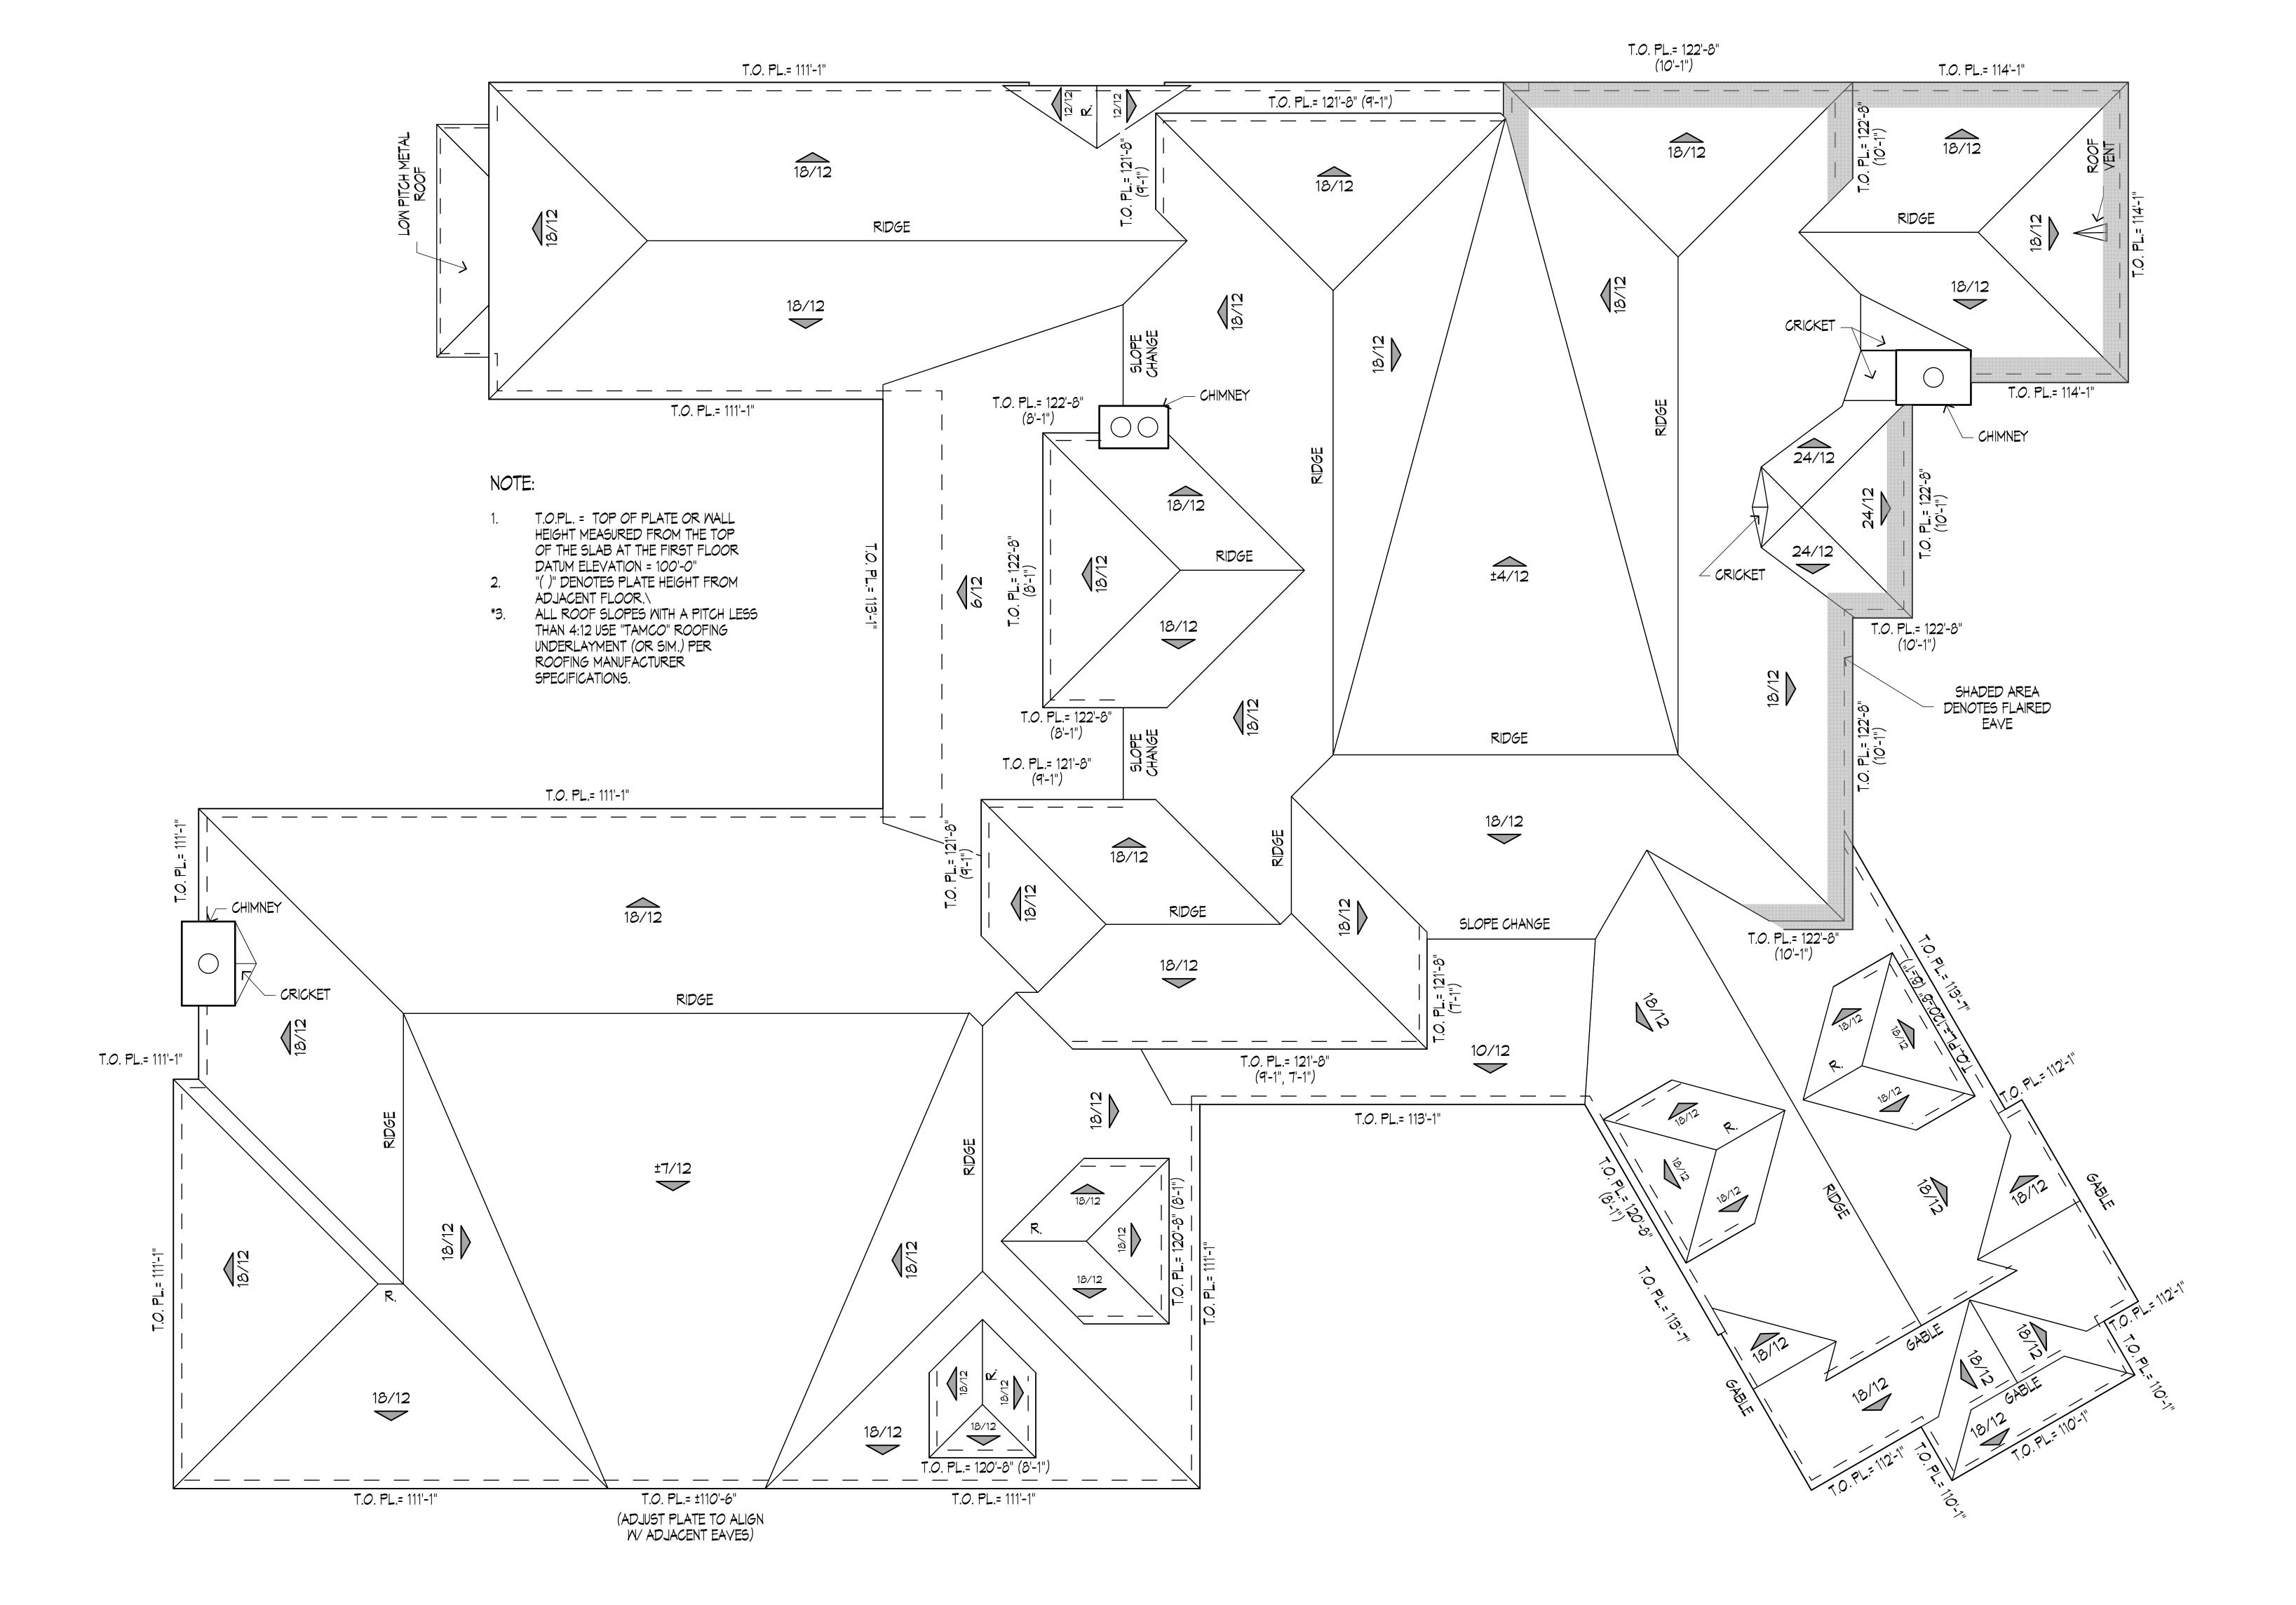
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SCALE: 1/4" = 1'-0"

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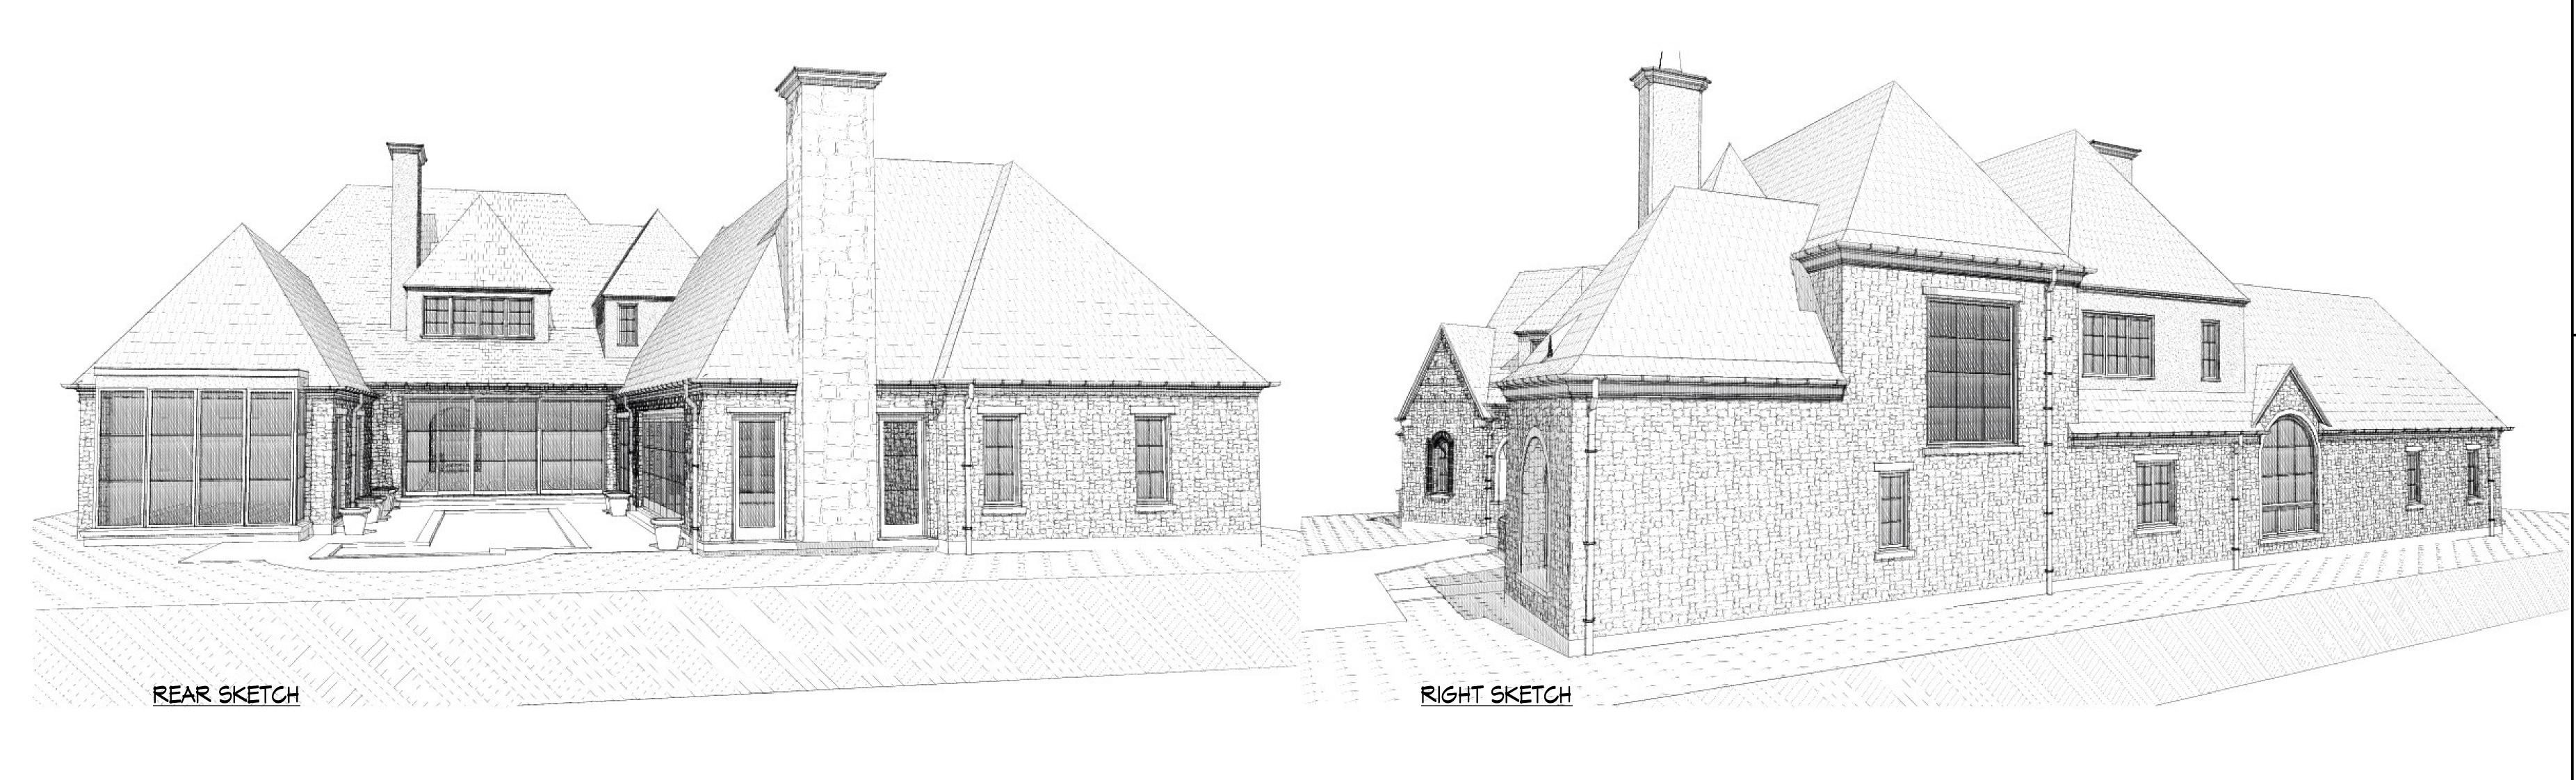
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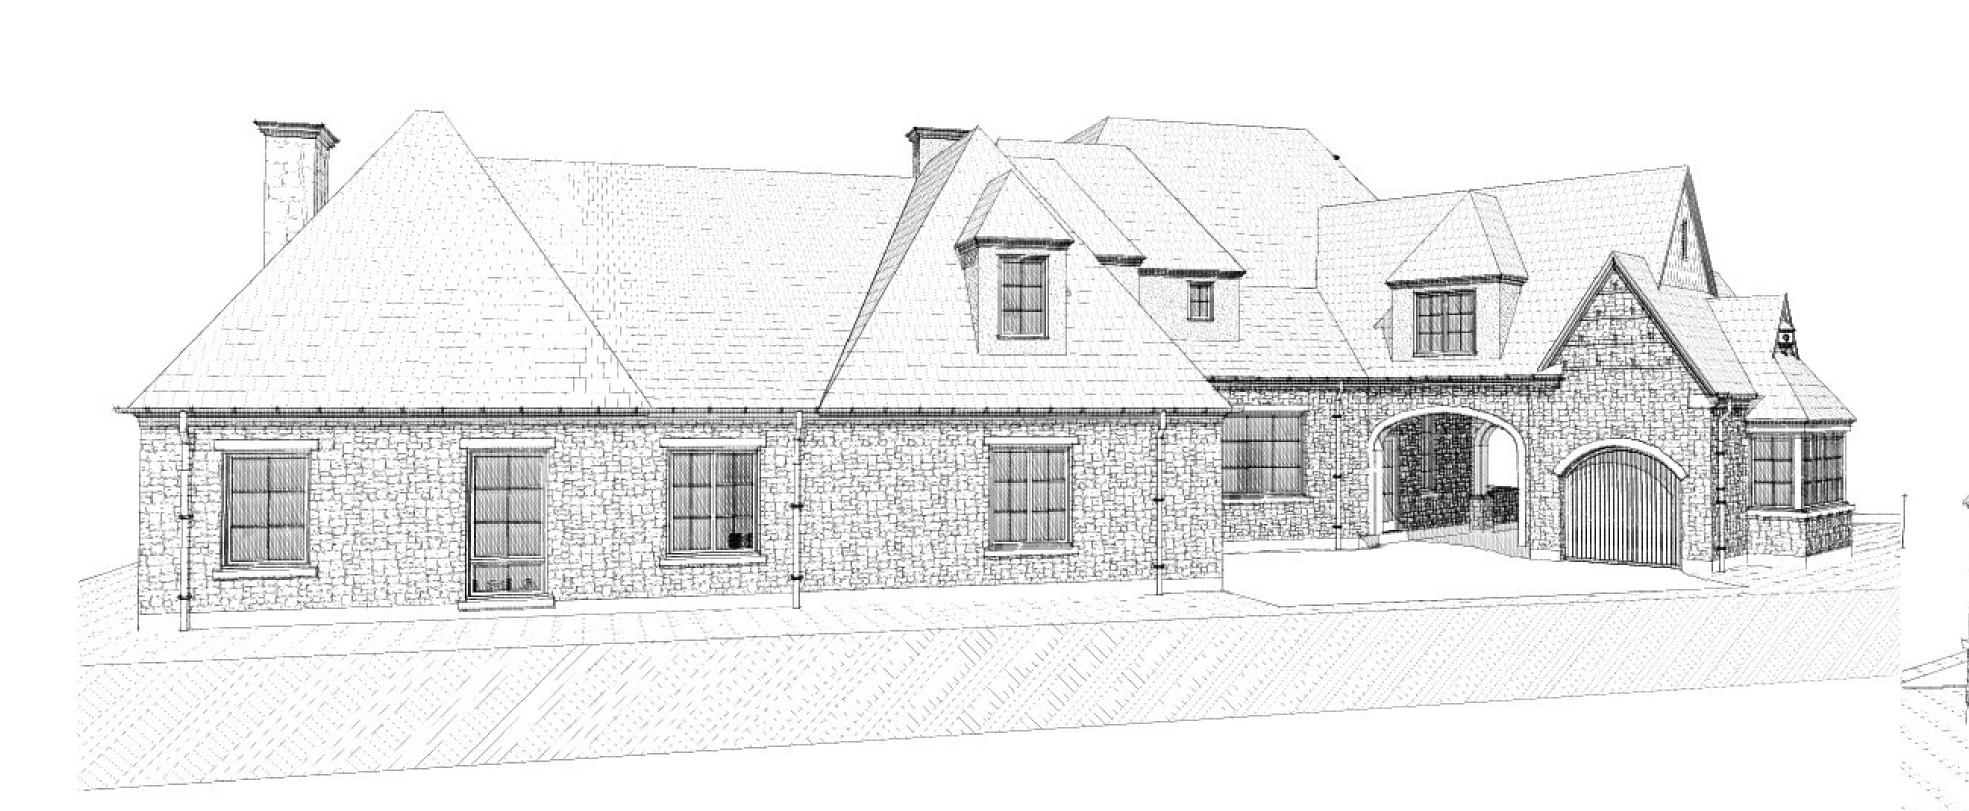
ROOF PLAN



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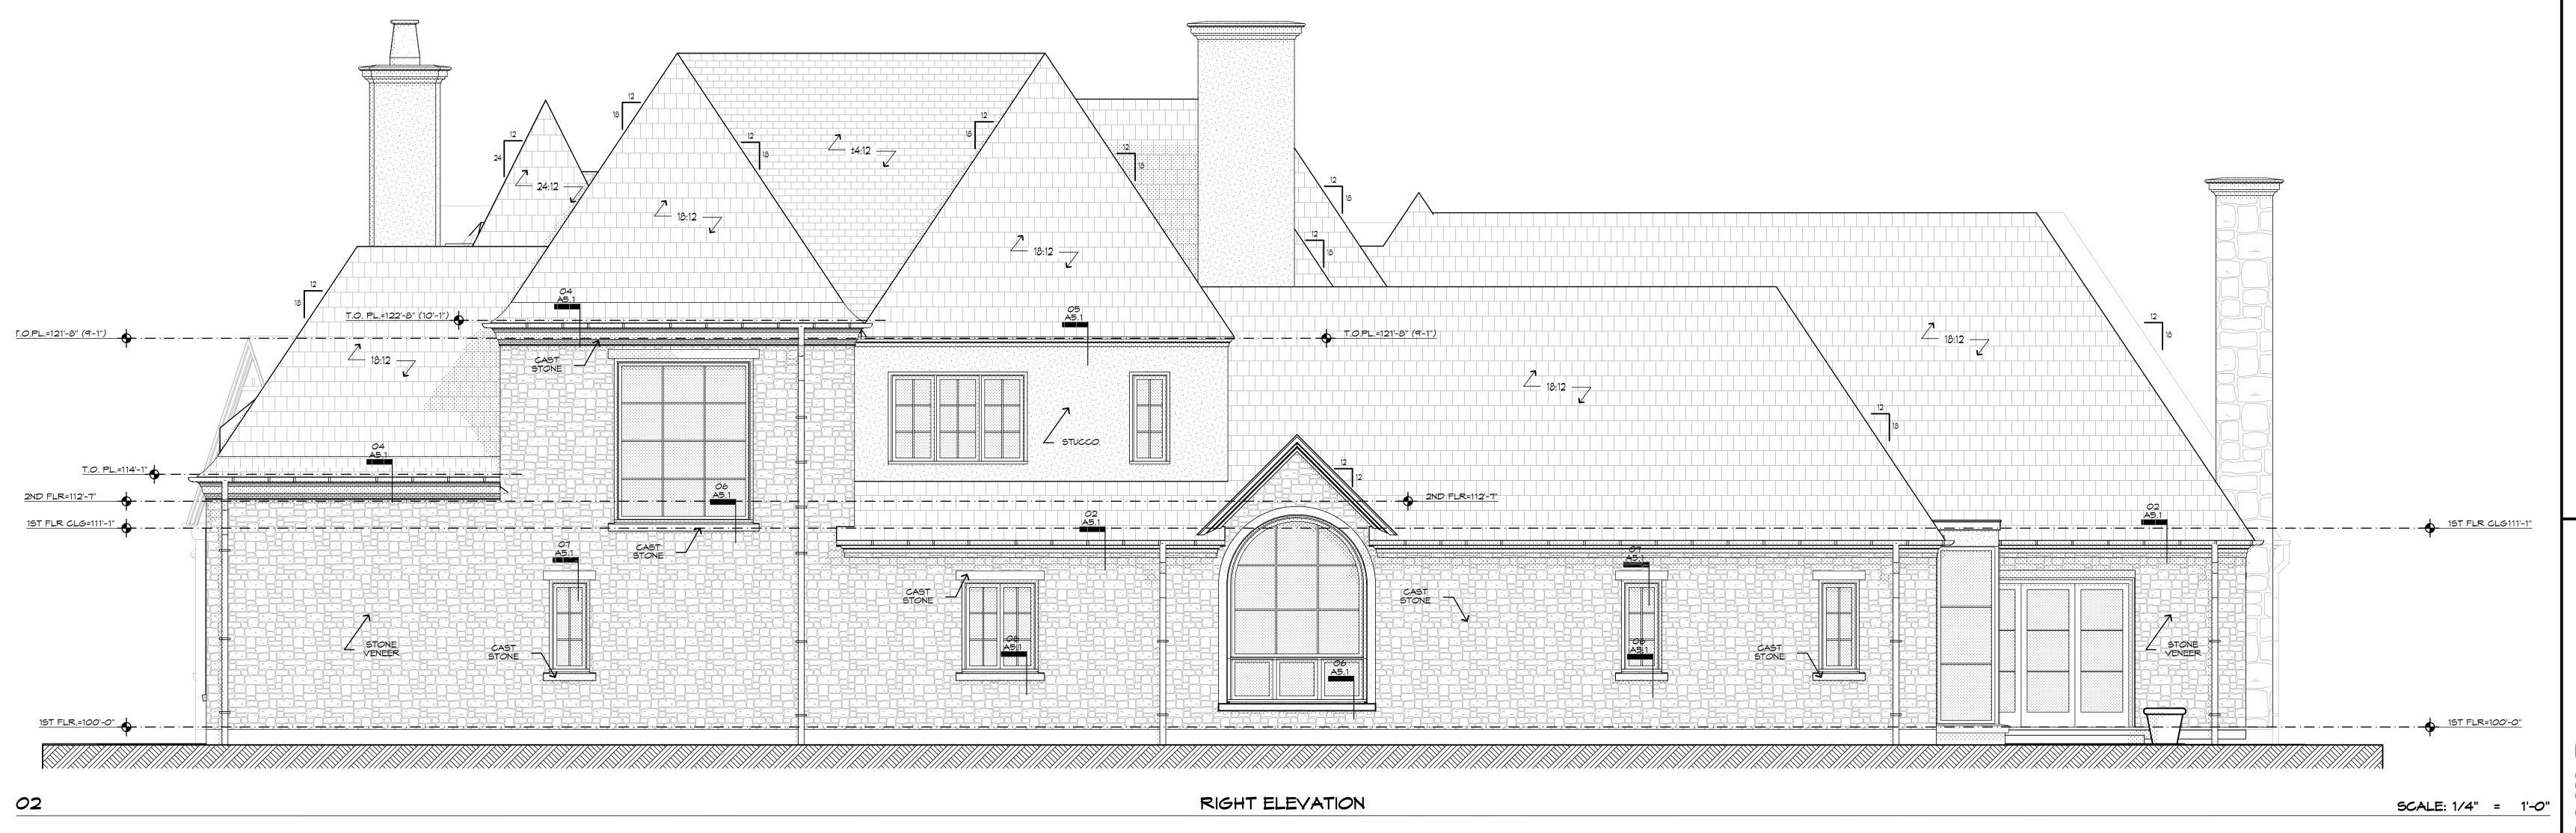
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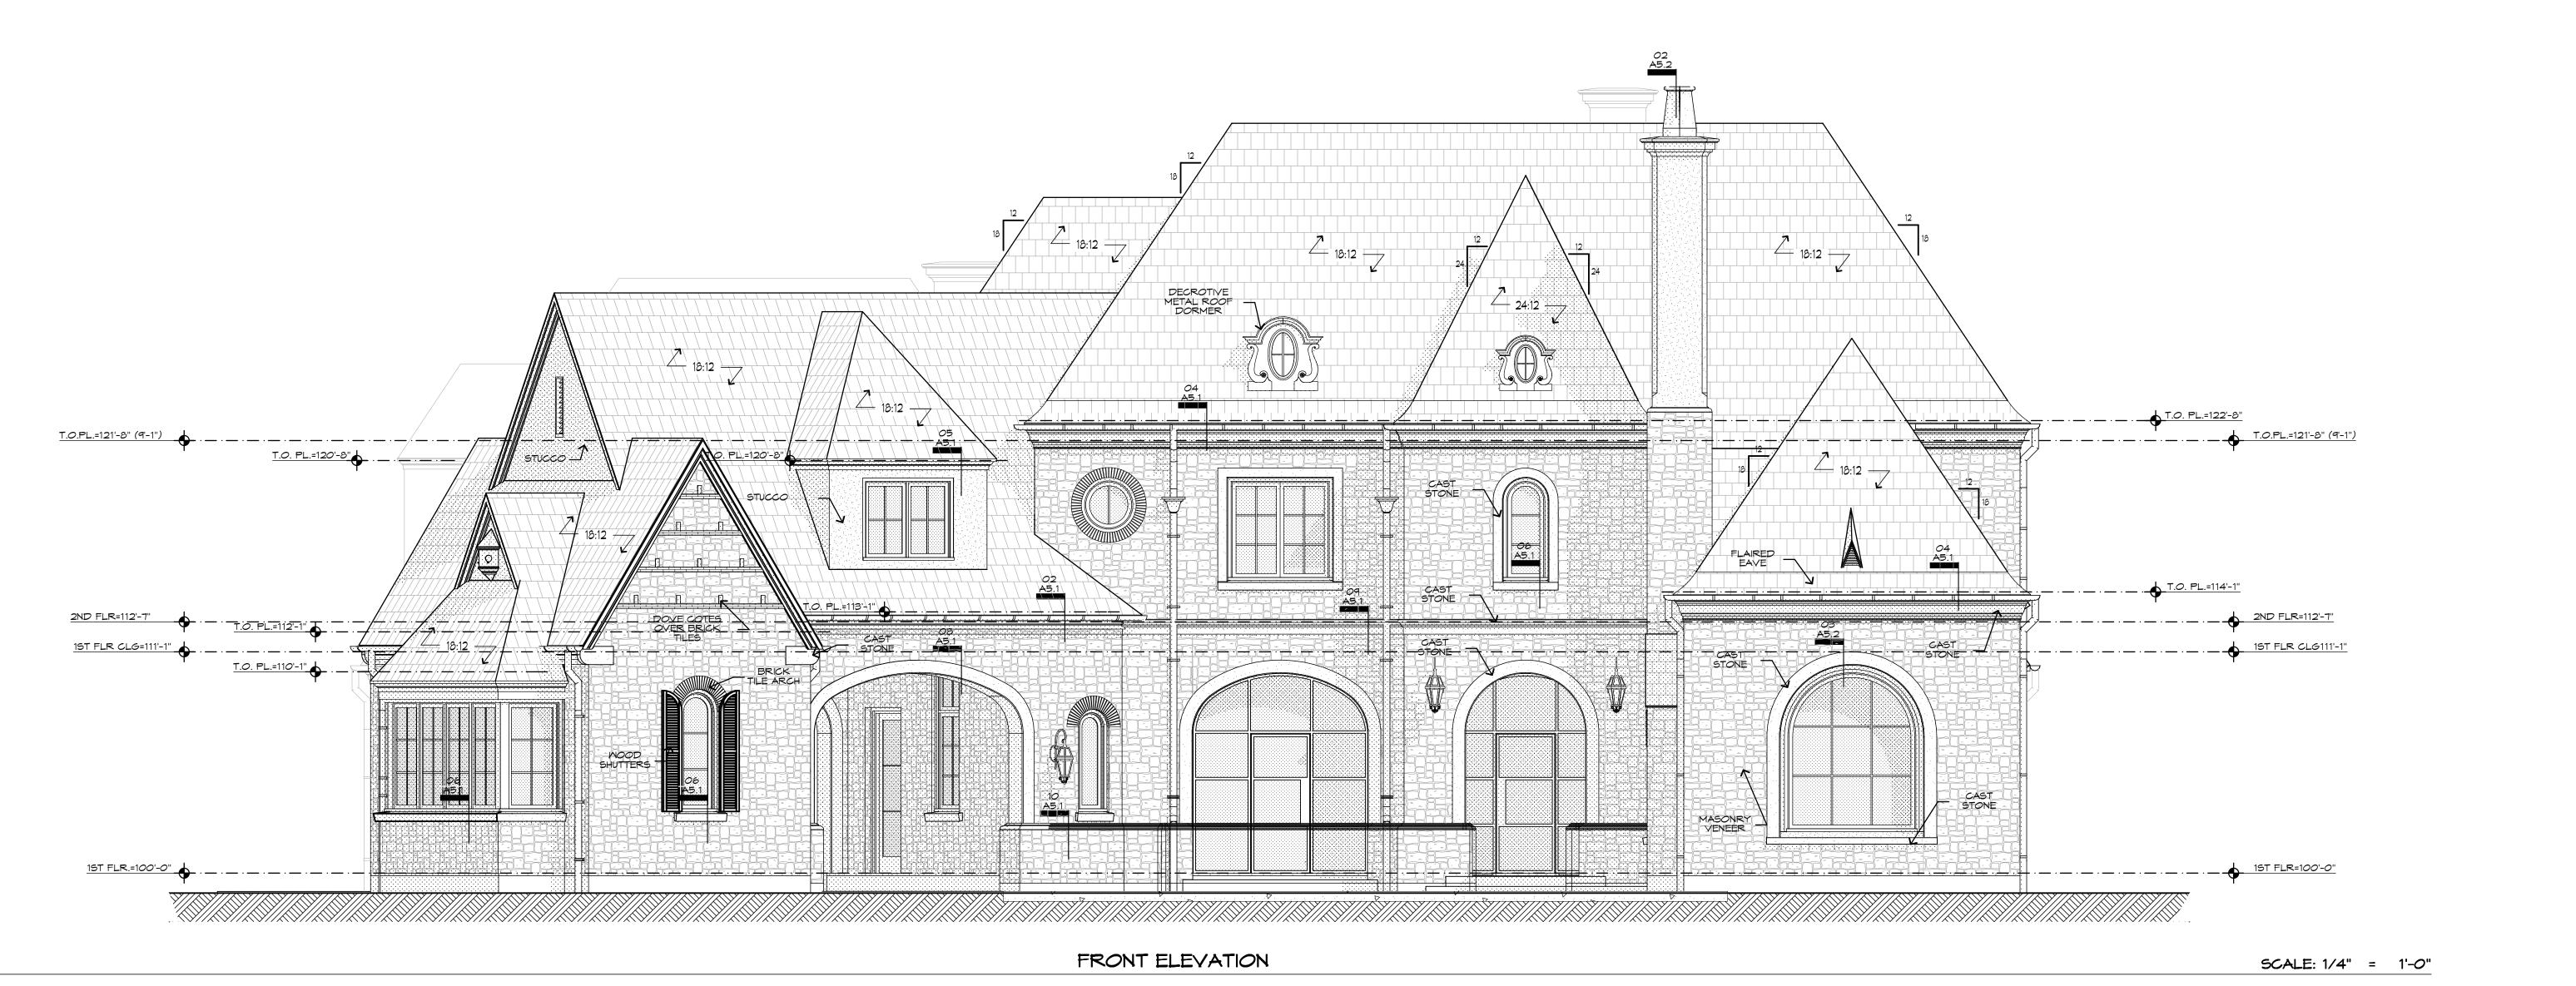




LEFT SKETCH

FRONT SKETCH





*O*1

MILAN DESIGN BUILD
5923 PARK LANE
LOT 8, BLK 1/5914

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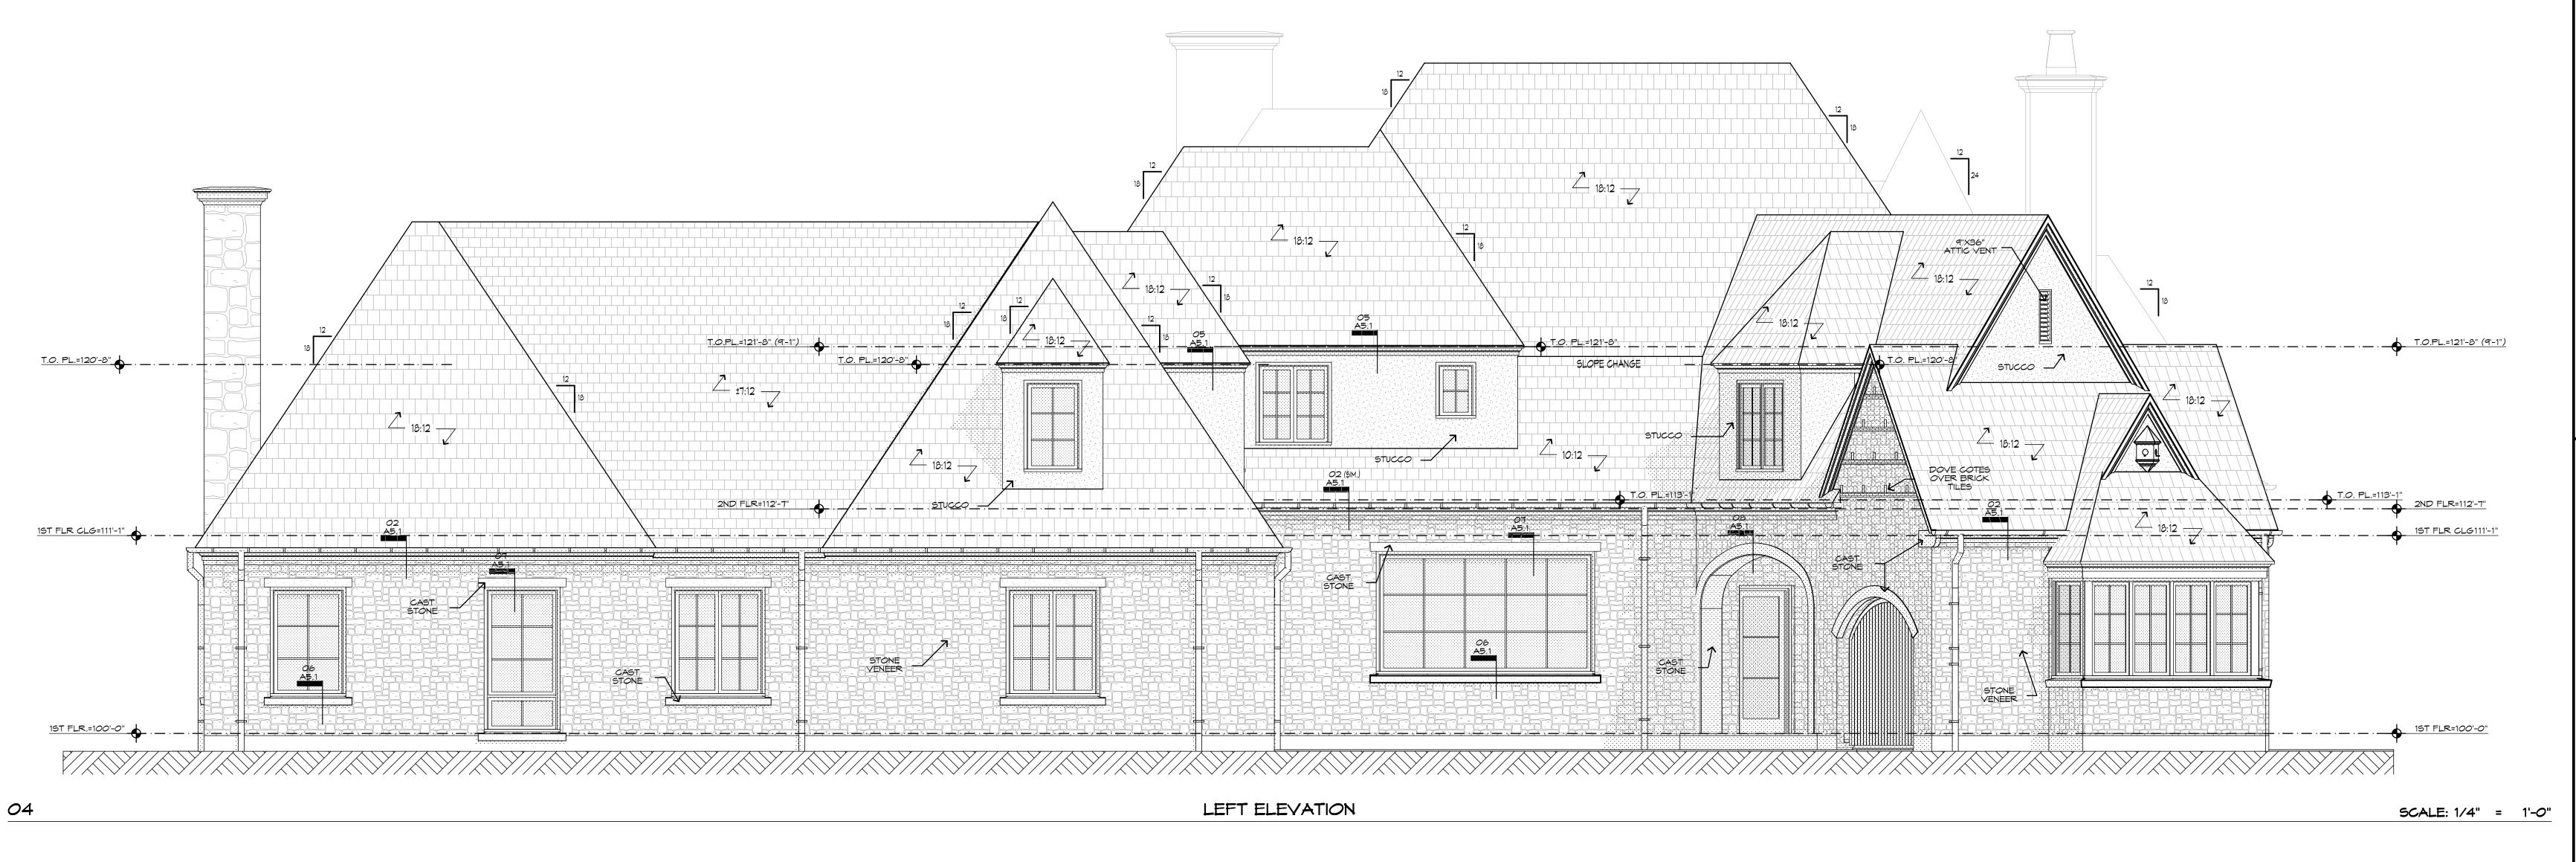
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PROJECT NUMBER 17005



REAR ELEVATION

03

MILAN DESIGN BUILD
5923 PARK LANE
LOT 8, BLK I/5914
DALLAS, TX

T.O.PL. = TOP OF PLATE OR WALL HEIGHT MEASURED FROM THE TOP OF THE SLAB AT THE FIRST FLOOR DATUM ELEVATION = 100-0"

"()" DENOTES PLATE HEIGHT FROM ADJACENT FLOOR.\

SCALE: 1/4" = 1'-0"

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15T FLR=100'-0"

SCALE: 1/4" = 1'-0"

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ISSUE DATE

05.12.17

REVIEW SET

REVISIONS

SCALE: 1/4" = 1'-0"

SHEET NUMBER

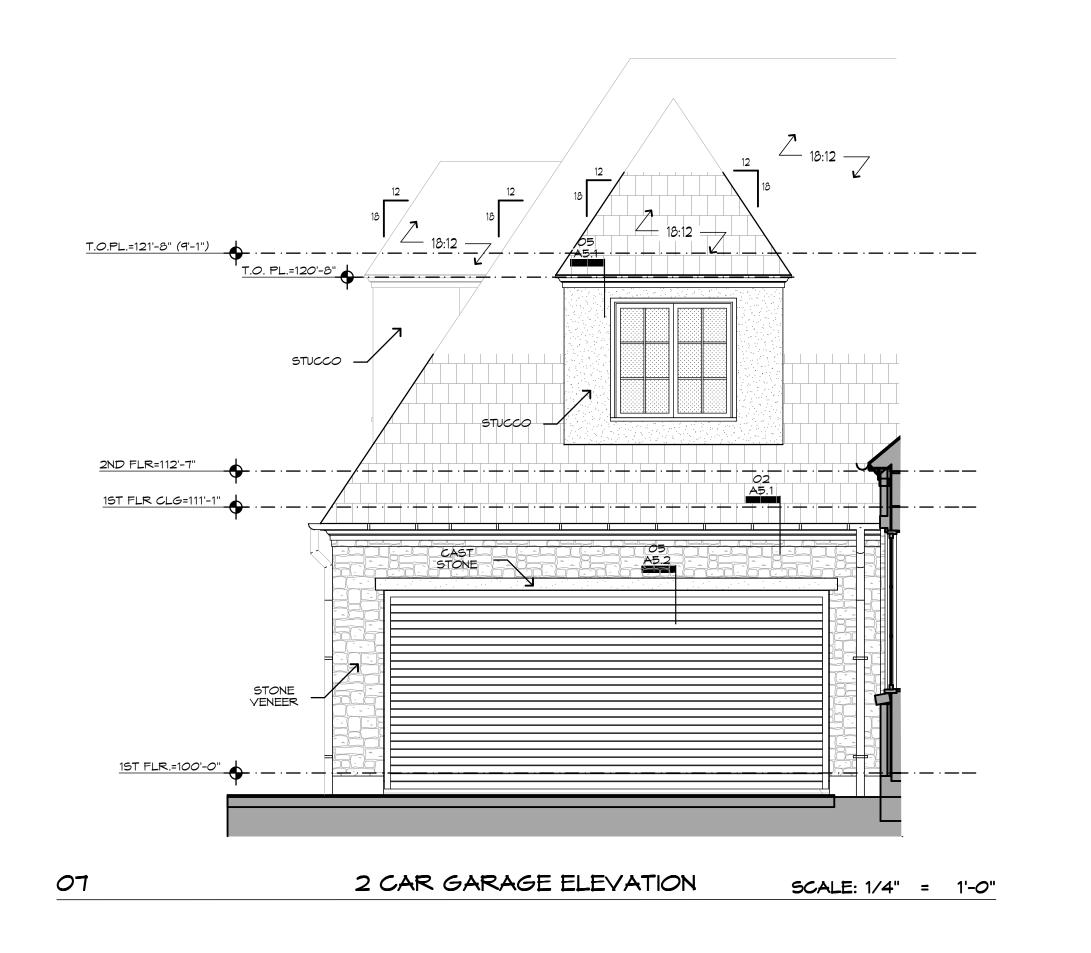
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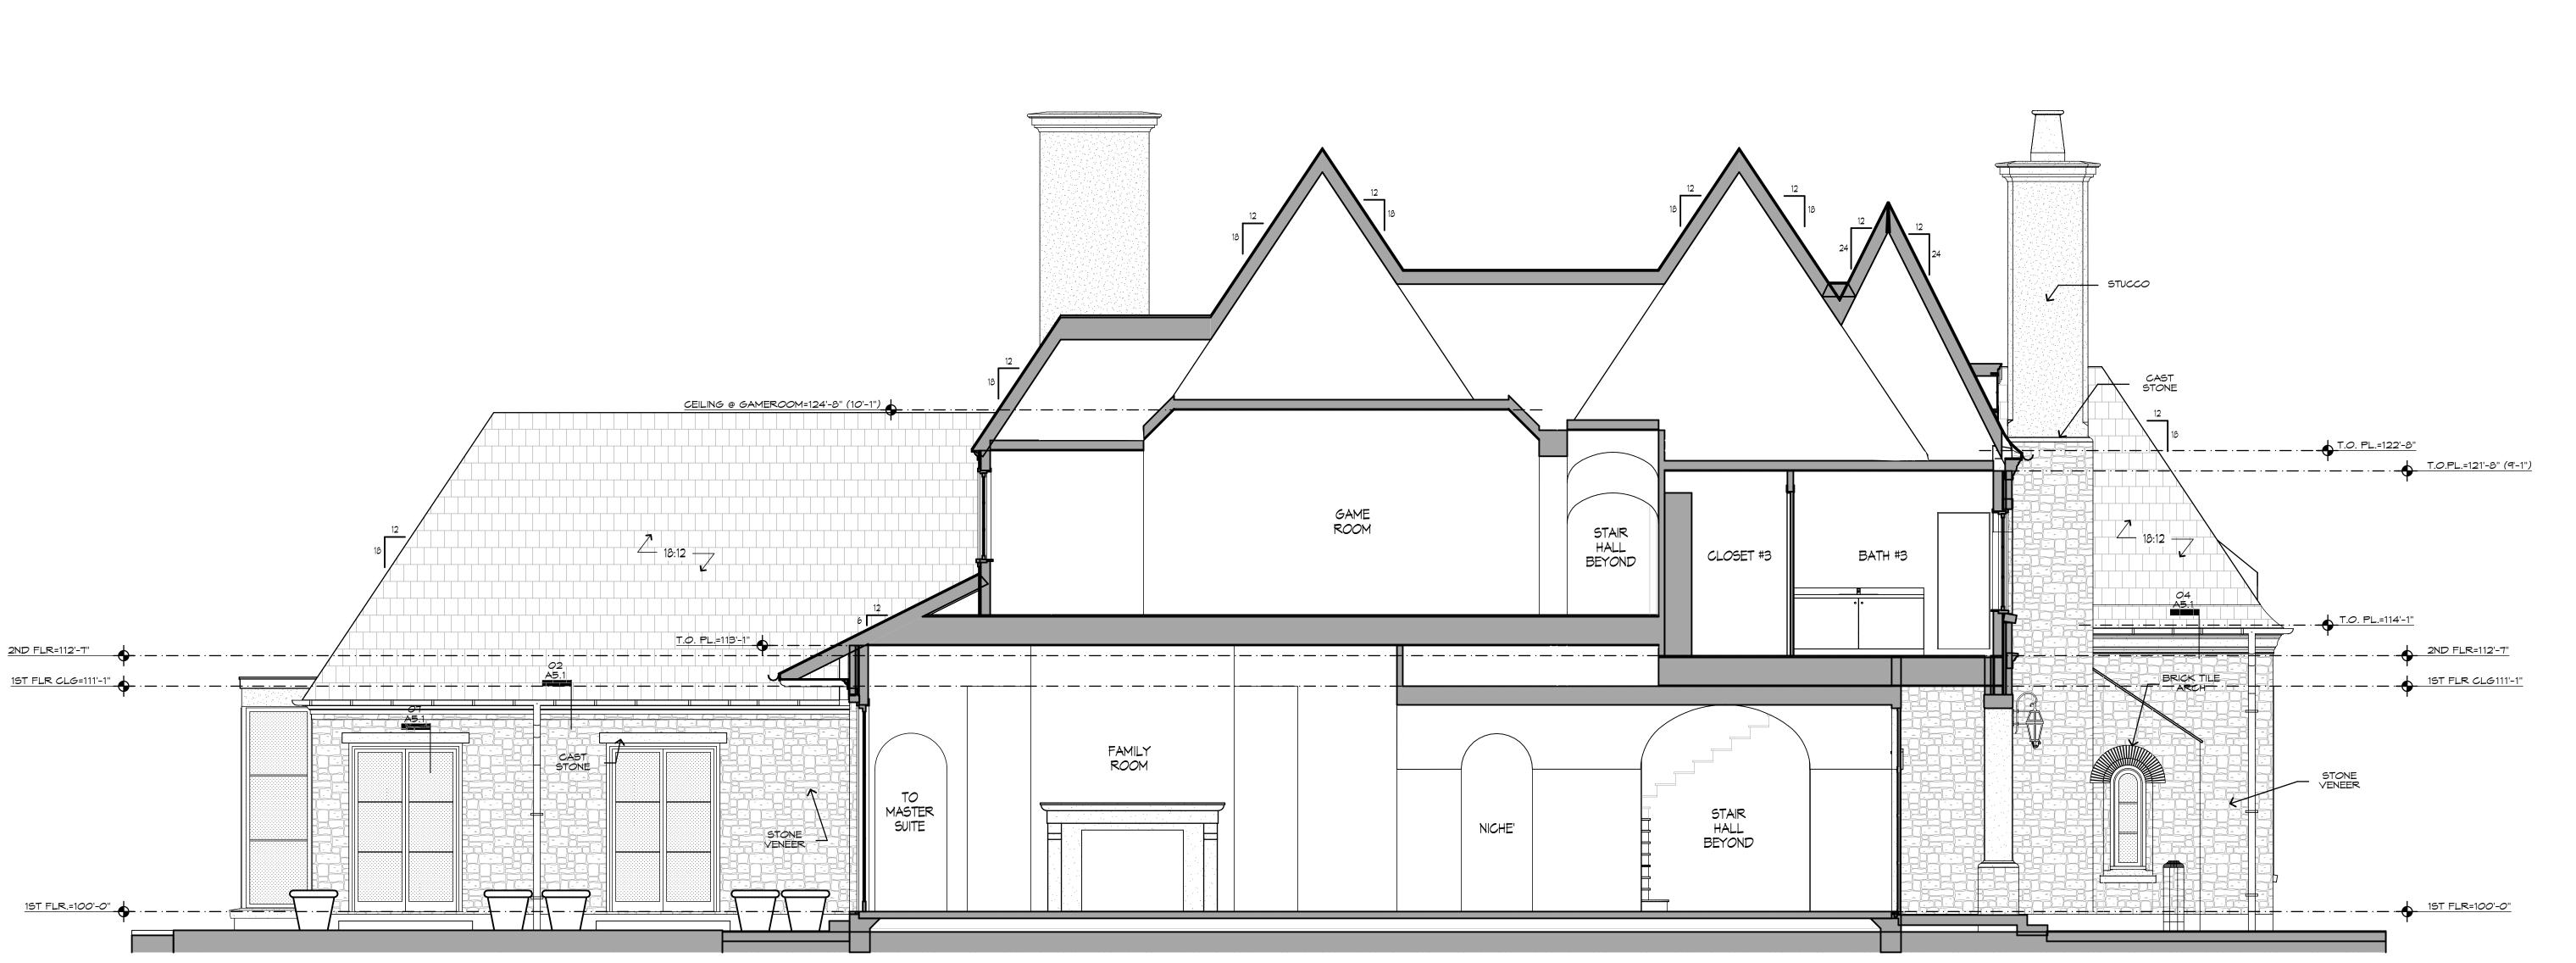
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17005

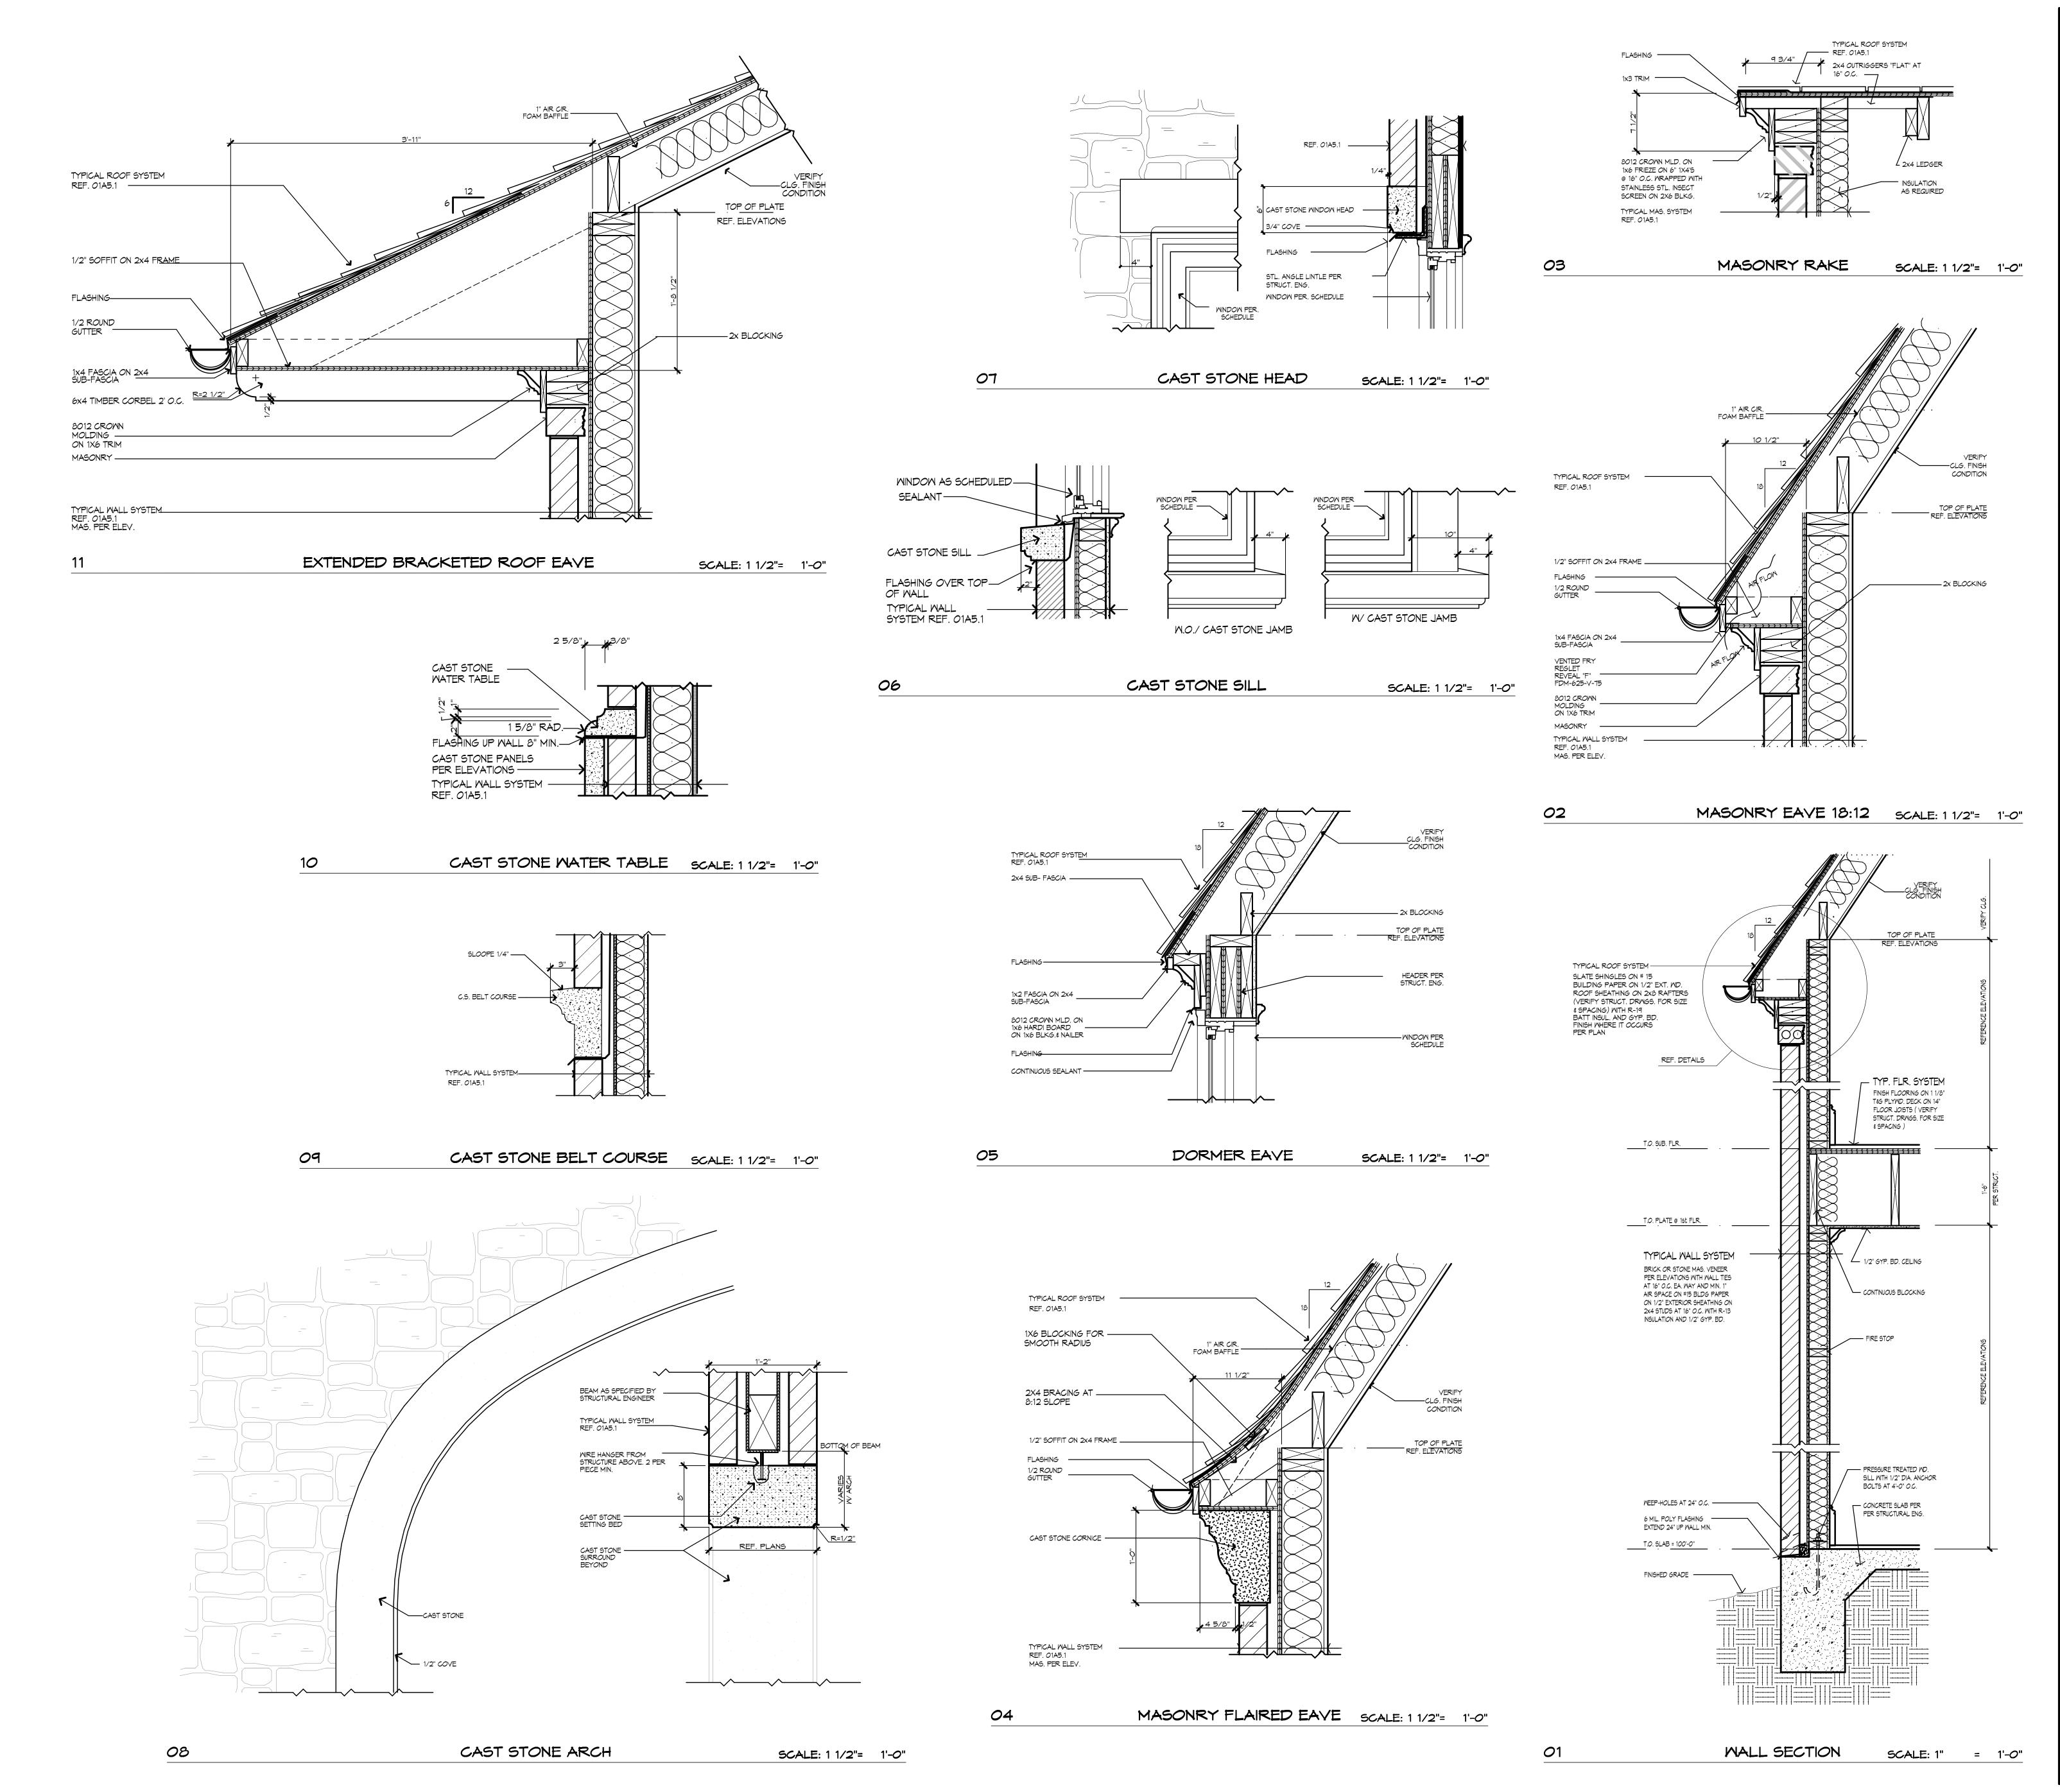
RIGHT INTERIOR ELEVATION

LEFT INTERIOR ELEVATION





06



C.A. NELSON ARCHITECTURE GROUP LLC
ARCHITECTURE INTERIORS CREATIVE SOLUTION
5220 Spring Valley Rd. Suite 210 Dallas, Texas 75254 972.248.1905 canelson@canelsonarchitects.cc

MILAN DESIGN BUILD
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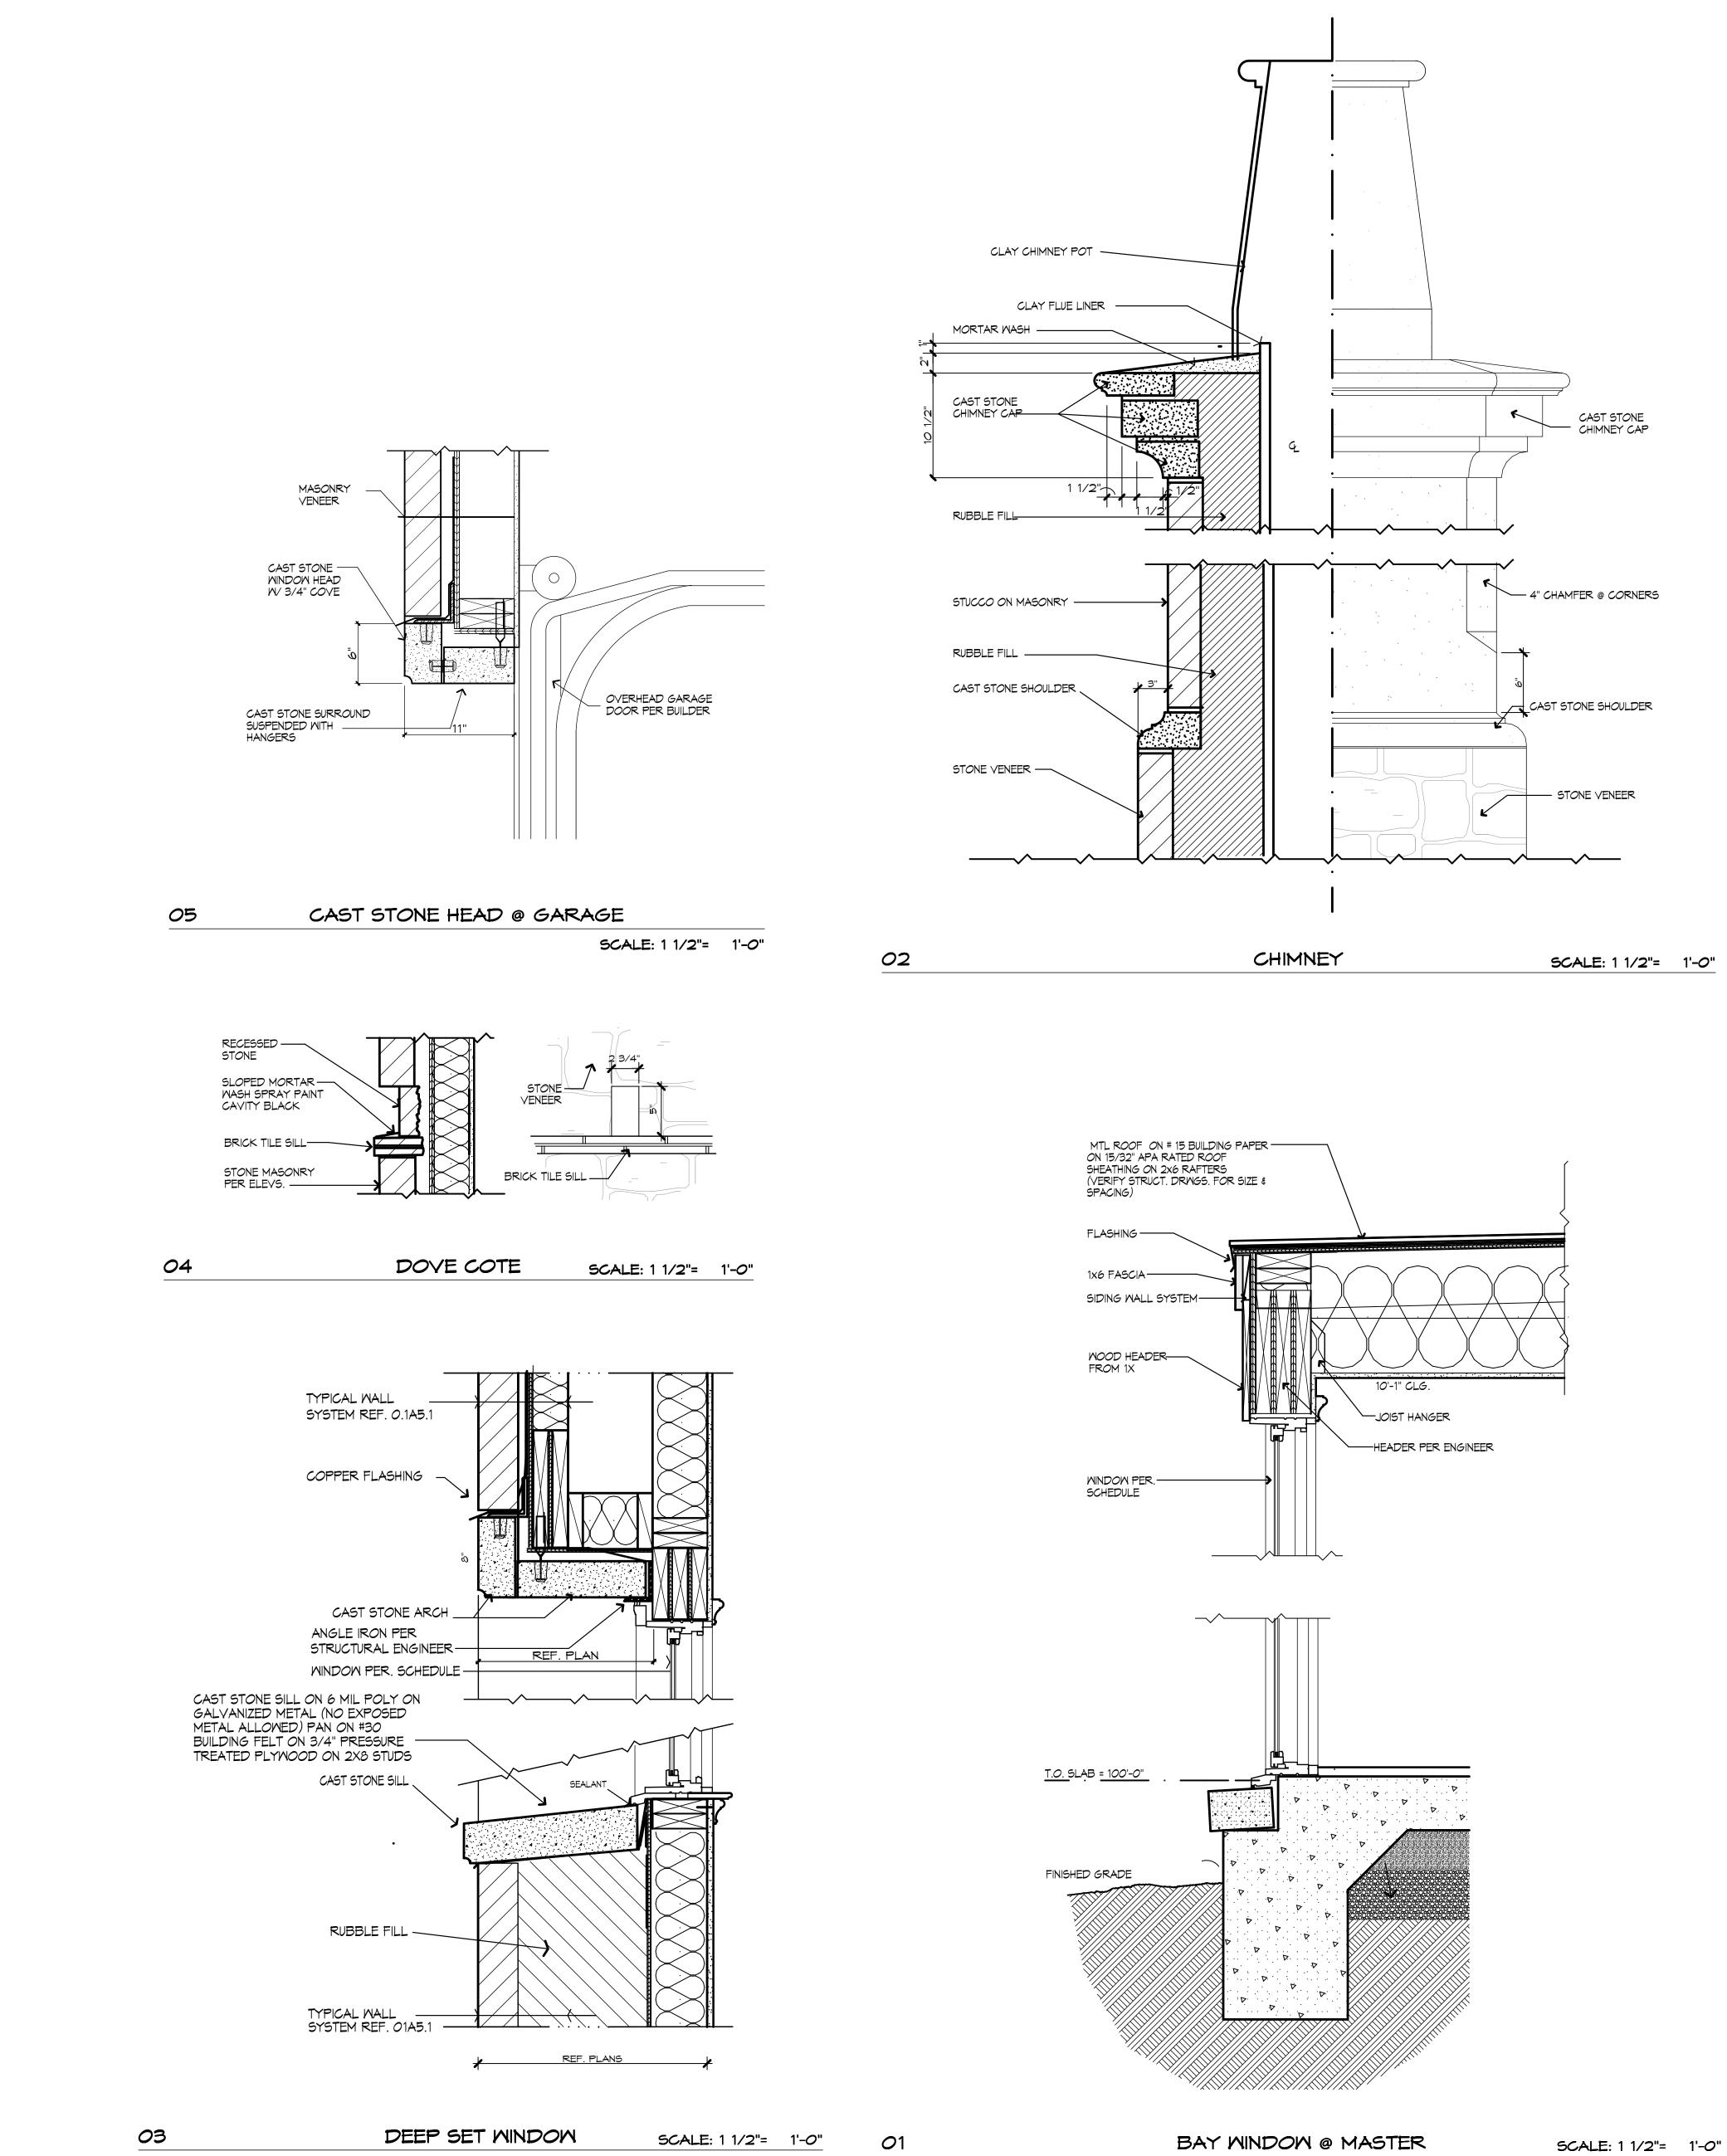
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SHEET NUMBER

A5.1

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17005



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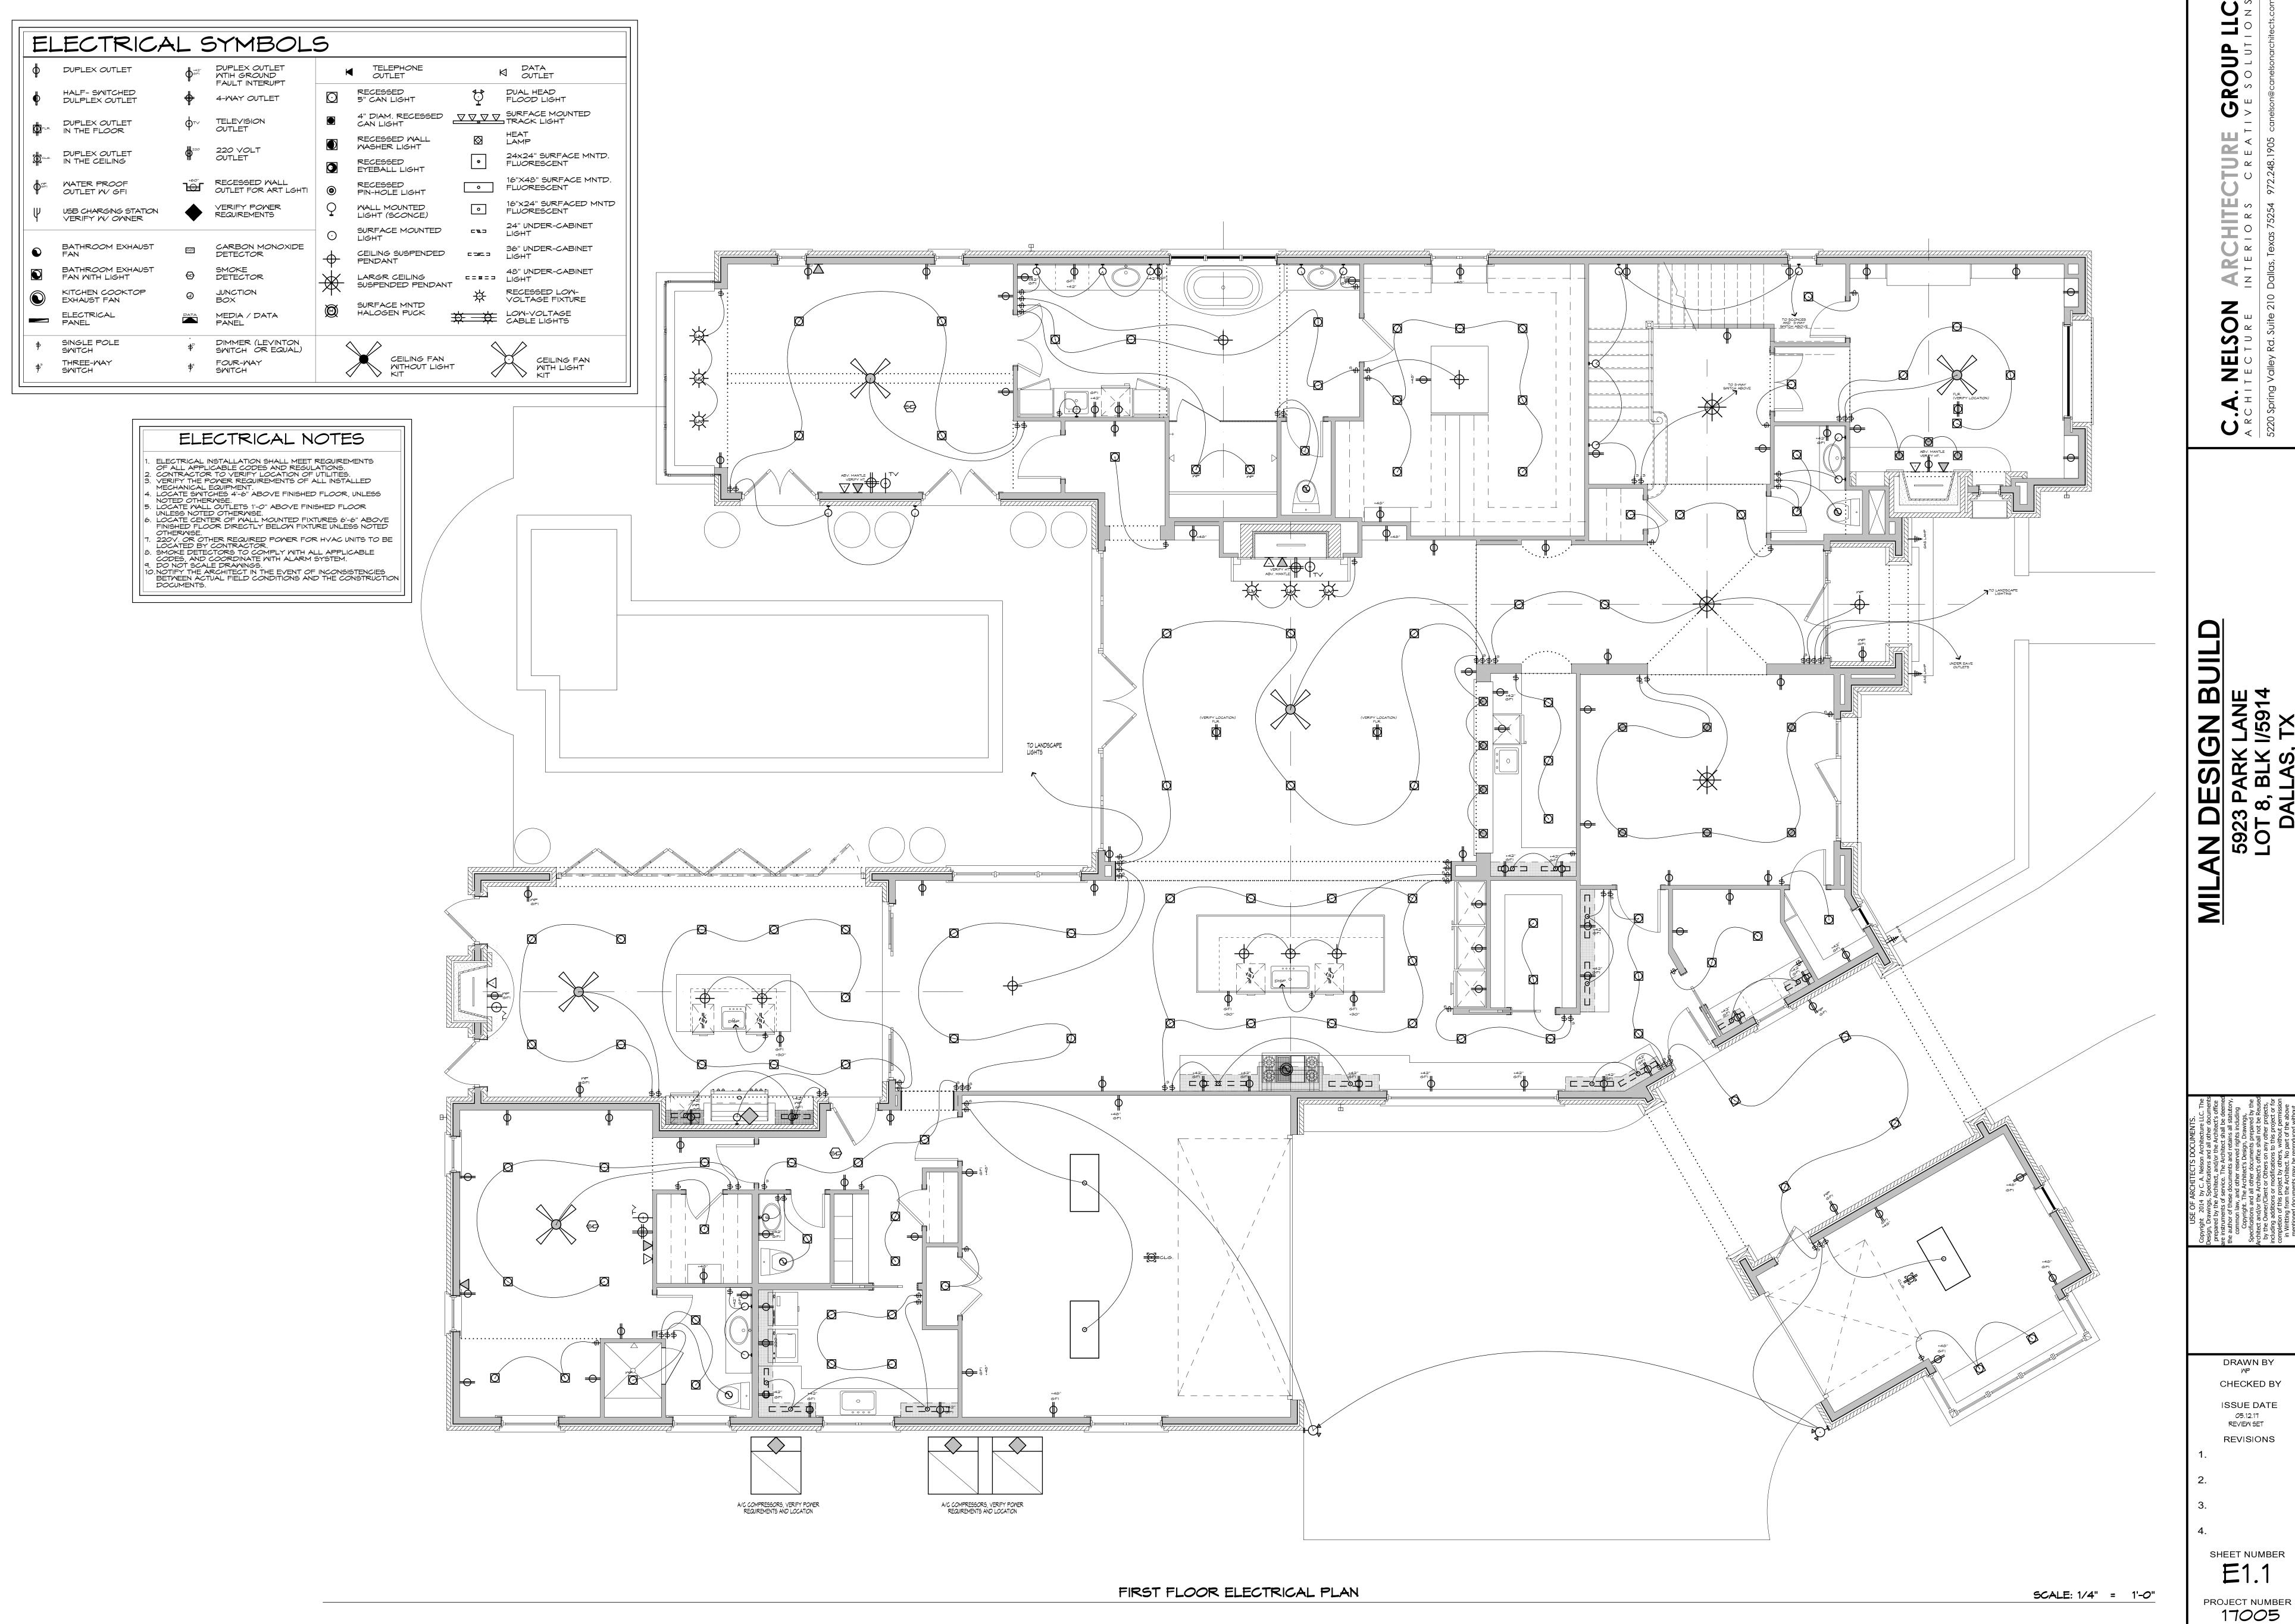
REVIEW SET

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SHEET NUMBER **A5.2**

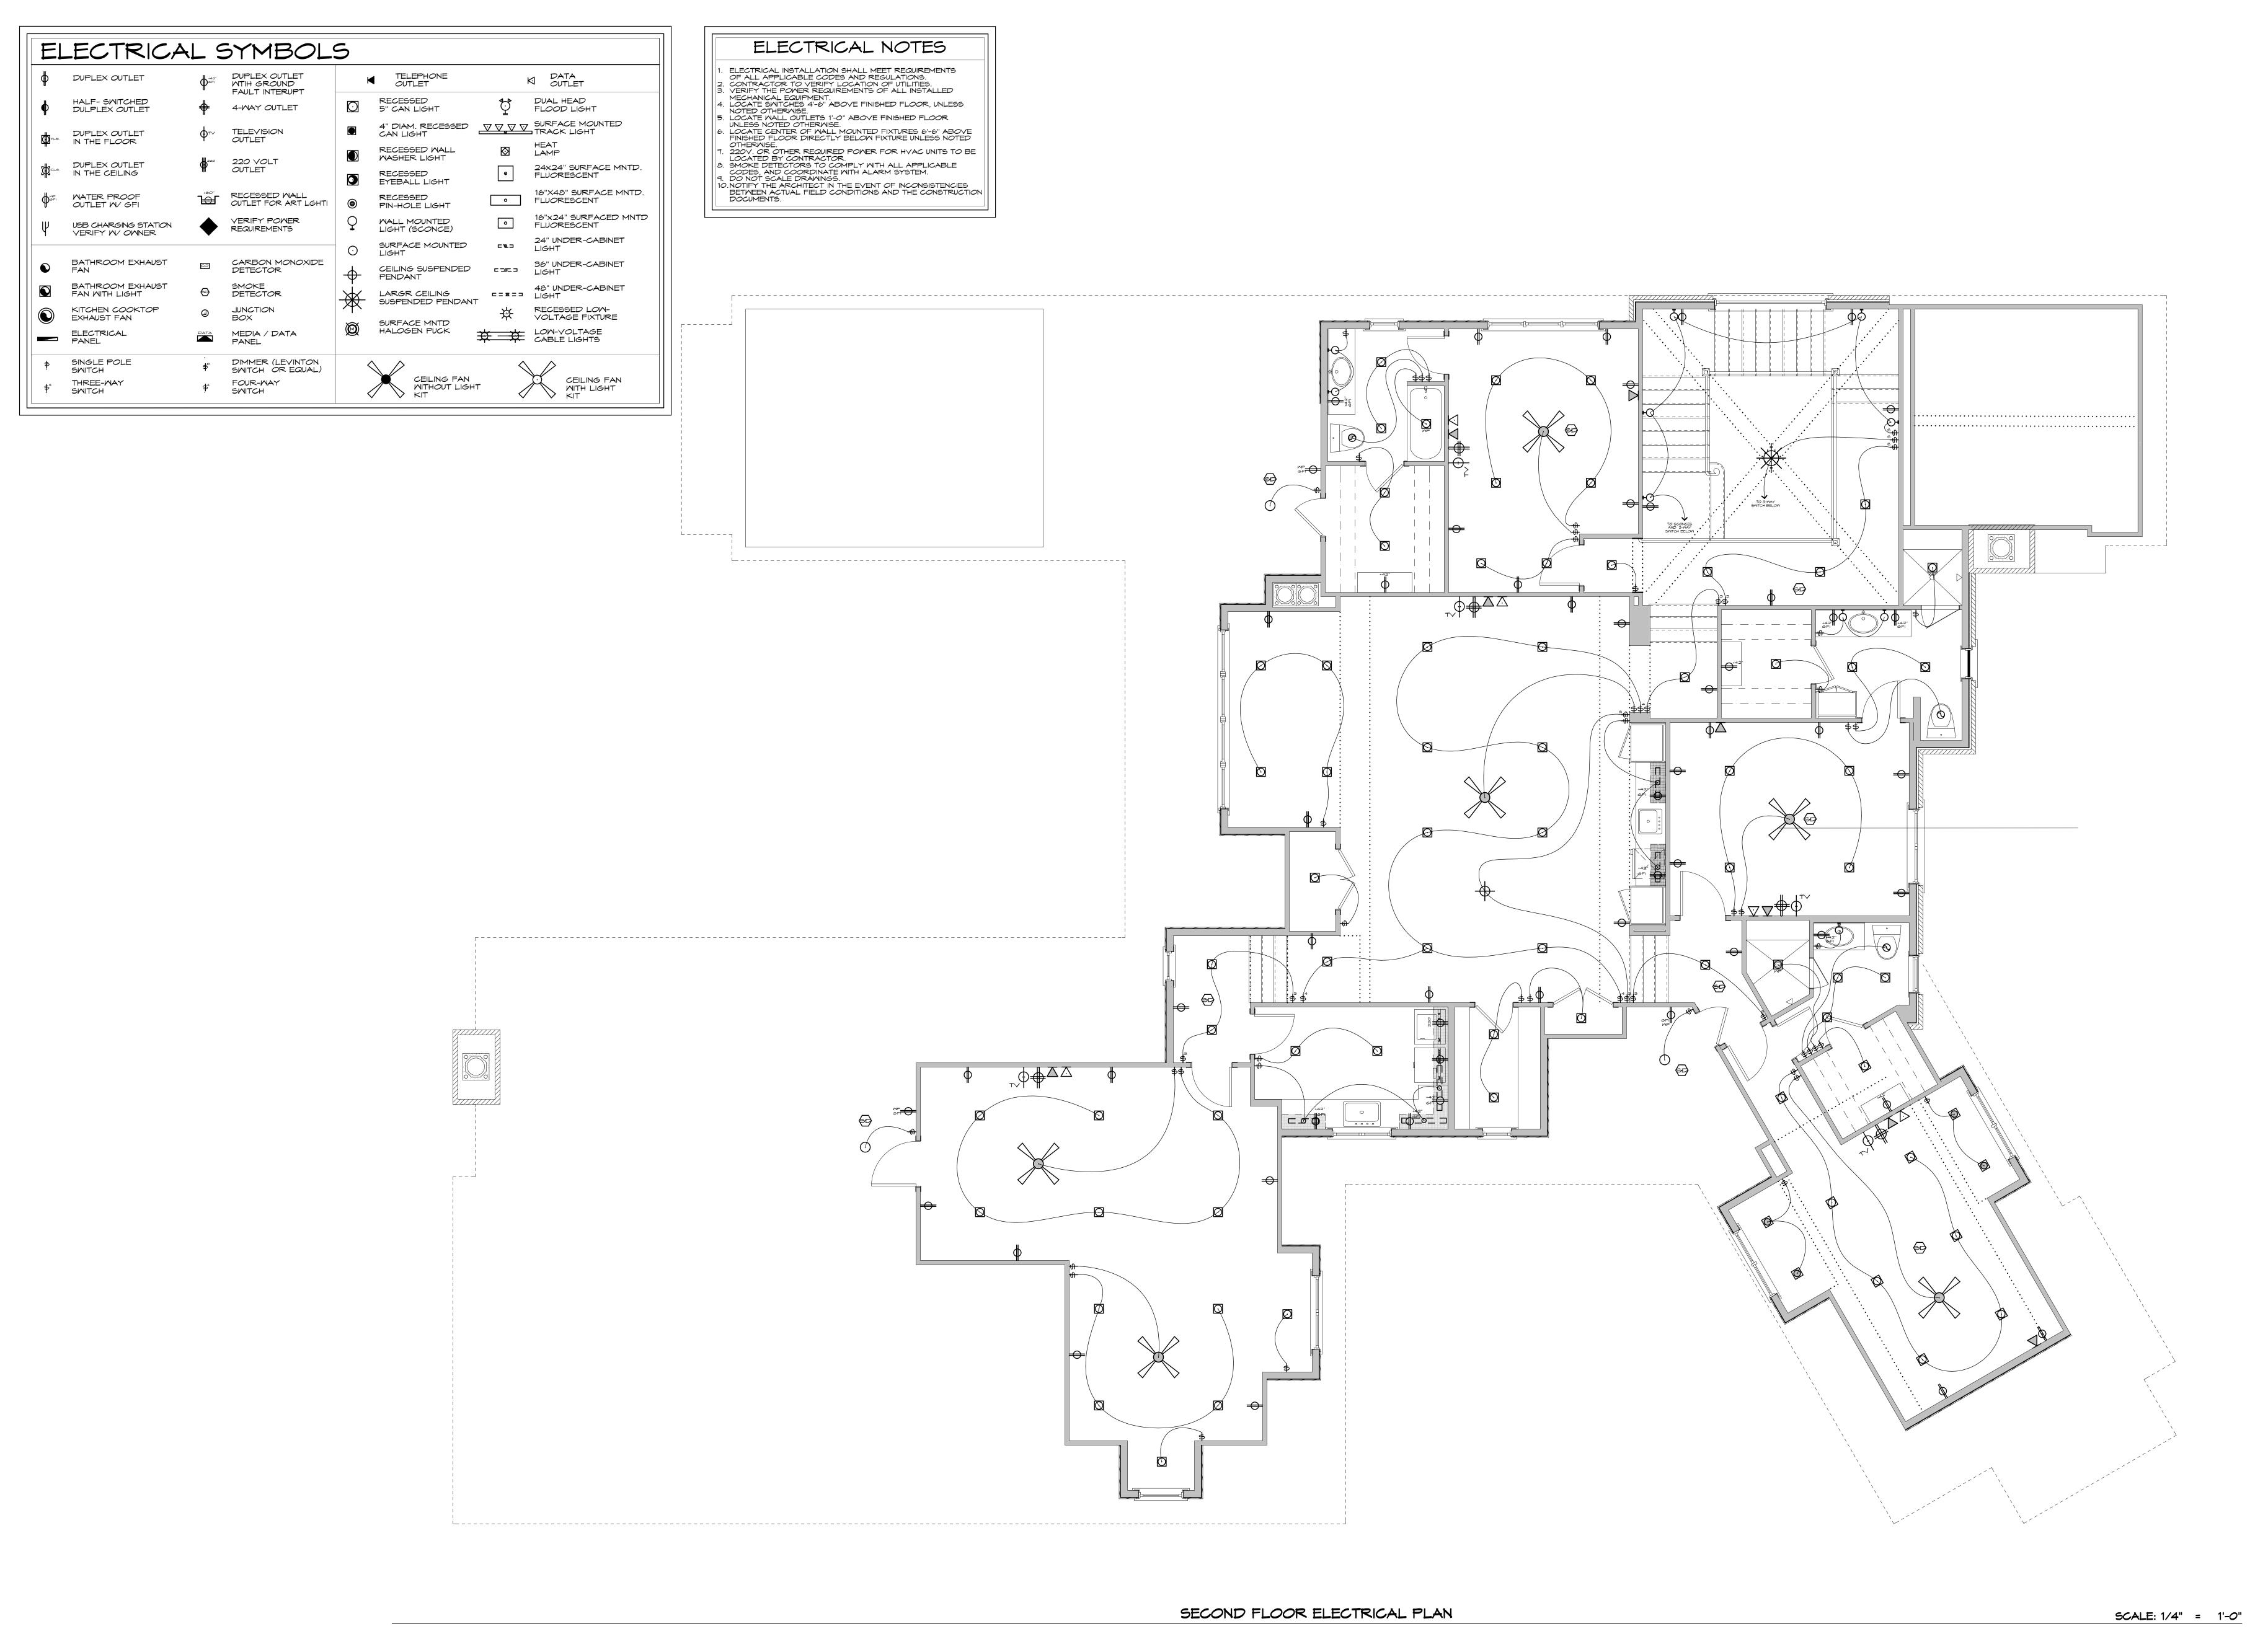
2"= 1'-0"
PROJECT NUMBER
17005



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